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| MINIMUM STRUCTURAL DESIGN LOADS |
| DESIGN LOADS: |
| SNOW - 55# |
| WIND - 100 MPH |
| SEISMIC DESIGN CATEGORY C |
| FROST DEPTH - 18 INCHES |
| EXPOSURE - C |
| MINIMUM UNIFORM LIVE LOADS |
| BALCONIES - 60 LBS. SQ.FT. |
| DECKS - 40 LBS. SQ.FT. |
| FIRE ESCAPES - 40 LBS. SQ.FT. |
| GARAGES - 50 LBS. SQ.FT. |
| ATTICS (NO STORAGE) - 10 LBS. SQ.FT. |
| ATTICS (LIMITED STORAGE) - 20 LBS. SQ.FT. |
| ATTICS (SERVED W/ FIXED STAIRS) - 30 LBS. SQ.FT. |
| DWELLINGS - 40 LBS. SQ.FT. |
| STAIRS - 40 LBS. SQ.FT. |
| GUARDRAILS & HANDRAILS 200 LBS. SQ.FT. |

ADDITIONAL ENERGY MEASURES PROVIDED.
RESIDENTIAL ENERGY ENVELOPE ENHANCEMENT MEASURE 3:
INSULATION :
FLOORS-
UNDERFLOOR- R30
SLAB EDGE PERIMETER- R15
HEATED SLAB, INTERIOR- R10
FLOOR ASSEMBLY OVER UNCONDITIONED SPACE- R30
WALLS-
ABOVE GRADE- R21
BELOW GRADE- R19 FOR FRAMED ASSEMBLIES OR R15 CONTINUOUS
CEILING-
FLAT- R49 WITH MIN R21 AT EDGE
SCISSOR TRUSS VAULT- R30
RAFTER VAULT- R30
WINDOWS- U0.30, AND PERFORMANCE TESTED DUCT SYSTEM

CONSERVATION MEASURE OPTION A- HIGH EFFICIENCY HVAC SYSTEM
GAS FIRED FURNACE OR BOILER WITH MINIMUM AFUE OF 90%
OR AIR-SOURCE HEAT PUMP WITH MINIMUM HSPF OF 8.5
OR CLOSED LOOP GROUND SOURCE HEAT PUMP WITH MINIMUM COP OR 3.0

GLAZING NOTE:
ALL GLAZING SHALL CONFORM TO ADDITIONAL ENERGY MEASURES SPECIFIED IN
ATTACHED ENERGY CHECKLIST

INSULATION NOTE:
ALL INSULATION SHALL CONFORM TO ADDITIONAL ENERGY MEASURES SPECIFIED IN
ATTACHED ENERGY CHECKLIST

ROB LITTLETON INC. DOES NOT REPRESENT ITSELF
AS AN ARCHITECT, ENGINEER OR SURVEYOR. IT IS
THE SOLE RESPONSIBILITY OF THE OWNER/
BUILDER TO OBTAIN ALL BUILDING PERMITS AND TO
VERIFY ALL DIMENSIONS, CONSTRUCTION METHODS
AND SITE CONDITIONS WITH THEIR CONTRACTOR,
ENGINEER AND/ OR SURVEYOR PRIOR TO
CONSTRUCTION.

RESERVED FOR BUILDING
DEPARTMENT STAMP



FRONT PERSPECTIVE



REAR (RIVER) PERSPECTIVE

| LAYOUT PAGE TABLE | | |
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| 4 | A1.02 | MAIN FLOOR PLAN |
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| 7 | A2.01 | EXTERIOR ELEVATIONS |
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| NUMBER | DESCRIPTION |
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PROJECT LOCATION:
ROLIN RESIDENCE
LOT 13 RIVER MEADOWS
BEND OR, 97107

PROJECT FOR:
SIENNA BUILDING COMPANY
STEVE MCDONNELL
541-241-0406

RESIDENTIAL CONSTRUCTION
AND DESIGN

541-280-1120 PH FO BOX 1167
541-510-1744 FAX BEND OR 97709
CCB# 165287

Rob Littleton Inc.

DATE:

1/6/2017

SCALE:

1/4"=1' U.N.O.

SHEET TITLE:
COVER SHEET

SHEET:
A0.01

GENERAL NOTES

GENERAL:

1. THE CONTRACTOR SHALL BE RESPONSIBLE FOR SAFETY IN THE AREA OF WORK IN ACCORDANCE WITH ALL APPLICABLE SAFETY CODES.
2. THE CONTRACTOR SHALL INDEMNIFY AND HOLD THE DESIGNER/ENGINEER HARMLESS FOR INJURY OR DEATH TO PERSONS OR FOR DAMAGE TO PROPERTY CAUSED BY NEGLIGENCE OF THE CONTRACTOR, HIS AGENTS, EMPLOYEES OR SUBCONTRACTORS.
3. EACH CONTRACTOR SHALL BE RESPONSIBLE FOR DAMAGE TO ADJACENT WORK AND SHALL REPAIR SAID DAMAGE AT HIS OWN EXPENSE. CONTRACTOR TO OBTAIN ALL PERMITS AND APPROVALS.
4. CODES: ALL WORK SHALL CONFORM TO THE APPLICABLE BUILDING CODES AND ORDINANCES. IN CASE OF CONFLICT WHERE METHODS OR STANDARDS OF INSTALLATION OF THE MATERIALS SPECIFIED DO NOT EQUAL OR EXCEED THE REQUIREMENTS OF THE LAWS OR ORDINANCES, THE LAWS OR ORDINANCES SHALL GOVERN. NOTIFY THE DESIGNER OF ALL CONFLICTS.

DIMENSIONS:

1. ALL INFORMATION SHOWN ON THE DRAWINGS, RELATIVE TO THE EXISTING CONDITIONS ARE GIVEN AS THE BEST PRESENT KNOWLEDGE BUT WITHOUT GUARANTEE OF ACCURACY, THE CONTRACTOR SHALL FIELD VERIFY EXISTING CONDITIONS AND DIMENSIONS AND SHALL NOTIFY THE DESIGNER OF ANY DISCREPANCIES OR CONDITION ADVERSELY AFFECTING THE DESIGN PRIOR TO PROCEEDING WITH THE WORK.
2. EXTERIOR DIMENSIONS OF PLANS ARE TO BUILDING GRIDLINES OR FACE OF FRAMING UNLESS NOTED OTHERWISE.
3. INTERIOR DIMENSIONS OF PLANS ARE TO GRIDLINES OR FACE OF FRAMING UNLESS NOTED OTHERWISE.
4. DO NOT SCALE DRAWINGS: THE CONTRACTOR SHALL USE DIMENSIONS SHOWN ON THE PLANS AND ACTUAL FIELD MEASUREMENTS. NOTIFY THE DESIGNER IF DISCREPANCIES ARE FOUND.
5. COORDINATION: THE CONTRACTOR SHALL BE RESPONSIBLE FOR THE VERIFICATION AND COORDINATION OF THE WORK OF ALL TRADES TO ASSURE COMPLIANCE WITH THE DRAWINGS AND SPECIFICATIONS.

FIRE PROTECTION:

1. PROVIDE FIRE PROTECTION AT ALL PENETRATIONS OF FIRE RATED ELEMENTS AS REQUIRED BY THE CODE.

CONSTRUCTION:

1. CONTRACTOR SHALL INVESTIGATE AND VERIFY LOCATIONS OF STRUCTURAL, MECHANICAL AND ELECTRICAL ELEMENTS AND OTHER EXISTING CONDITIONS PRIOR TO BEGINNING THE WORK.
2. CONTRACTOR SHALL BE RESPONSIBLE FOR PROVIDING WALL BLOCKING FOR ALL WALL AND CEILING MOUNTED ITEMS.
3. THERE SHALL BE NO EXPOSED PIPES, CONDUITS, DUCTS, VENTS, ETC. ALL SUCH LINES SHALL BE CONCEALED OR FURRED AND FINISHED, UNLESS NOTED AS EXPOSED ON THE CONSTRUCTION DRAWINGS.
4. PROVIDE GALVANIC ISOLATION BETWEEN DISSIMILAR METALS.
5. GENERAL CONTRACTOR IS TO COORDINATE WITH ELECTRICAL AND PLUMBING CONTRACTORS FOR ALL REQUIRED ROUGH-INS AND TRENCHING REQUIRED FOR ELECTRICAL AND PLUMBING RUNS.
6. PROVIDE PRESSURE TREATED WOOD AT ALL LOCATIONS WHERE WOOD IS TO BE EXPOSED TO THE EXTERIOR OR WHERE WOOD COMES INTO CONTACT WITH CONCRETE OR SOIL.

CARPENTRY:

SAWN LUMBER DESIGN IS BASED ON THE NATIONAL DESIGN SPECIFICATION, LATEST EDITION. SAWN LUMBER SHALL CONFORM TO WEST COAST LUMBER INSPECTION BUREAU OR WESTERN WOOD PRODUCTS ASSOCIATION GRADING RULES. ALL LUMBER NOT SPECIFICALLY NOTED TO BE D.F. #2 OR BETTER. ALL WOOD IN PERMANENT CONTACT WITH CONCRETE OR CMU SHALL BE PRESSURE TREATED UNLESS AN APPROVED BARRIER IS PROVIDED. FRAMING ACCESSORIES AND STRUCTURAL FASTENERS SHALL BE MANUFACTURED BY SIMPSON STRONG-TIE COMPANY (OR ENGINEER APPROVED EQUAL) AND OF THE SIZE AND TYPE SHOWN ON THE DRAWINGS. HANGERS NOT SHOWN SHALL BE SIMPSON HU OF SIZE RECOMMENDED FOR MEMBER. ALL HANGERS AND NAILS IN CONTACT WITH PRESSURE TREATED LUMBER SHALL BE SIMPSON Z-MAX HANGERS OR STAINLESS STEEL. ALL SHEAR WALL SHEATHING NAILS SHALL BE COMMON NAILS. ALL FRAMING NAILS SHALL BE COMMON NAILS, OR HOT DIPPED GALVANIZED BOX NAILS. FRAMING NAILS SHALL BE PER IBC TABLE 2304.9.1 OR IRC TABLE R602.3(1).

PLYWOOD PANELS SHALL CONFORM TO THE REQUIREMENTS OF "U.S. PRODUCT STANDARD PS 1 FOR CONSTRUCTION AND INDUSTRIAL PLYWOOD" OR APA PRP-108 PERFORMANCE STANDARDS. UNLESS NOTED, PANELS SHALL BE APA RATED SHEATHING, EXPOSURE 1, OF THE THICKNESS AND SPAN RATING SHOWN ON THE DRAWINGS. PLYWOOD INSTALLATION SHALL BE IN CONFORMANCE WITH APA RECOMMENDATIONS. ALLOW 1/8" SPACING AT PANELS ENDS AND EDGES, UNLESS OTHERWISE RECOMMENDED BY THE PANEL MANUFACTURER.

ALL ROOF SHEATHING AND SUB-FLOORING SHALL BE INSTALLED WITH FACE GRAIN PERPENDICULAR TO SUPPORTS, EXCEPT AS INDICATED ON THE DRAWINGS. SHEAR WALL SHEATHING SHALL BE BLOCKED WITH 2X FRAMING AT ALL PANEL EDGES. NAILING NOT SPECIFICALLY IDENTIFIED ON THE DRAWINGS TO CONFORM WITH IRC TABLE R602.3(1).

GLUED LAMINATED MEMBERS SHALL BE FABRICATED IN CONFORMANCE WITH U.S. PRODUCT STANDARD PS 56, "STRUCTURAL GLUED LAMINATED TIMBER" AND AMERICAN INSTITUTE OF TIMBER CONSTRUCTION, AITC 117. EACH MEMBER SHALL BEAR AN AITC OR APA-EWS IDENTIFICATION MARK AND BE ACCOMPANIED BY A CERTIFICATE OF CONFORMANCE. ONE COAT OF END SEALER SHALL BE APPLIED IMMEDIATELY AFTER TRIMMING IN EITHER SHOP OR FIELD. GLULAM HANGERS NOT SHOWN SHALL BE SIMPSON EG. BEAMS SHALL BE VISUALLY GRADED WESTERN SPECIES INDUSTRIAL GRADE, AND OF THE STRENGTH INDICATED BELOW:

| DEPTH | COMBINATION SYMBOL | SPECIES | USE |
|-------|-----------------------|---------|-----------------------|
| ALL | 24F - V4 | DF/DF | (SIMPLE SPAN) |
| ALL | 24F - V8 | DF/DF | (CONT. OR CANTILEVER) |

PREMANUFACTURED WOOD JOISTS: PREMANUFACTURED WOOD JOISTS SHALL BE OF THE SIZE AND TYPE SHOWN ON THE DRAWINGS, MANUFACTURED BY THE TRUS JOIST COMPANY, OR AN ENGINEER APPROVED EQUAL. PROVIDE BRIDGING IN CONFORMANCE WITH THE MANUFACTURERS RECOMMENDATIONS. JOISTS AND BRIDGING SHALL BE CAPABLE OF RESISTING THE WIND UPLIFT NOTED ON THE DRAWINGS. THE JOIST MANUFACTURER SHALL VISIT JOB SITE AS REQUIRED AND VERIFY THE PROPER INSTALLATION OF JOISTS IN WRITING TO THE ARCHITECT/ENGINEER. PREMANUFACTURED WOOD JOIST ALTERNATES WILL BE CONSIDERED, PROVIDED THE ALTERNATE IS COMPATIBLE WITH THE LOAD CAPACITY, STIFFNESS, DIMENSIONAL, AND FIRE RATING REQUIREMENTS OF THE PROJECT, AND IS ICBO APPROVED.

LUMBER SPECIES:

- A. POSTS, BEAMS, HEADERS, JOISTS, AND RAFTERS TO BE DF-#2
- B. EXPOSED ARCH BEAMS TO BE DF-#1 OR BETTER
- C. SILLS, PLATES BLOCKING, AND BRIDGING TO BE DF-#2.
- D. ALL STUDS TO BE DF#2 OR BETTER.
- E. PLYWOOD SHEATHING SHALL BE AS FOLLOWS:
ROOF SHEATHING SHALL BE 1/2" CDX INT-APA RATED 32/16 OR 5/8" OSB.
WALL SHEATHING SHALL BE 1/2" INT-APA RATED 32/16 OR 1/16" OSB.
FLOOR SHEATHING SHALL BE 3/4" T & G INT-APA RATED OSB.
- F. '1' JOISTS SHALL BE MANUFACTURED BY TRUS JOIST OR ENGINEER APPROVED EQUAL.
- G. ALL WOOD IN CONTACT WITH CONCRETE SHALL BE PRESSURE TREATED.

NAILING NOTES: (PER IRC TABLE R602.3(1))
UNLESS SPECIFIED IN ENGINEERS CALCULATIONS

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| JOIST TO SILL OR GIRDER SOLE PLATE TO JOIST OR BLK'G STUD TO SOLE PLATE TOP PLATE TO STUD | TOE NAIL (3)-8d FACE NAIL 16d @ 16" OC TOE NAIL (4)-8d, END NAIL (2) 16d END NAIL (2)-16d |
| DOUBLE STUDS DOUBLE TOP PLATES CONTINUOUS HEADER, TWO PIECES TOP PLATES, LAPS AND INTERSECTIONS | FACE NAIL 16d @ 24" OC FACE NAIL 16d @ 16" OC 16d @ 16" OC ALONG EA. EDGE FACE NAIL (2)-16d |
| CEILING JOISTS TO PLATE CONTINUOUS HEADER TO STUD CEILING JOISTS TO PARALLEL RAFTERS RAFTER TO PLATE BUILT-UP CORNER STUDS | TOE NAIL (3)-8d TOE NAIL (4)-8d FACE NAIL (3)-10d TOE NAIL (2)-16d 10d @ 24" OC |
| PLYWOOD -OSB ROOF AND WALL SHEATHING | EDGES 8d @ 6" OC INTERMEDIATE 8d @ 12" OC (U.N.O. IN ENG.) |
| PLYWOOD SUBFLOOR | EDGES 8d @ 6" OC INTERMEDIATE 8d @ 12" OC |

GENERAL PLUMBING & HVAC NOTES:

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| HVAC SHALL BE ZONED WHERE APPLIES |
| THE HEAT SOURCE SHALL CONFORM TO THE SPECIFICATIONS SET FORTH IN THE ADDITIONAL ENERGY MEASURES SUPPLIED FOR THIS PROJECT |
| METALLIC GAS PIPE, WATER PIPE, AND FOUNDATION REINFORCING BARS SHALL BE BONDED TO THE ELECTRICAL SERVICE GROUND. |
| DRYER, WATER HEATER, KITCHEN AND BATHROOM VENTING SHALL EXHAUST TO THE OUTSIDE OF THE BUILDING AND BE EQUIPPED WITH A BACK DRAFT DAMPER. |
| ALL GAS LINES SHALL BE SIZED FOR APPLIANCE LOAD. "BLACK" PIPE SHALL BE USED INSIDE THE BUILDING, "GREEN" PIPE WHERE UNDERGROUND OR EXPOSED TO WEATHER. ALL JOINTS SHALL BE TAPED WHERE BURIED OR EXPOSED TO WEATHER. |
| TUBS/SHOWERS SHALL BE PROVIDED WITH INDIVIDUAL CONTROL VALVES OF THE PRESSURE BALANCE OR THE THERMOSTATIC MIXING TYPE. THE WATER TEMPERATURE SHALL BE AT A MAXIMUM OF 120°F. |
| A MINIMUM OF ONE EXTERIOR HOSE BIB SHALL BE SUPPLIED- CONFIRM WITH BUILDER |
| HEAT DUCTING SHALL BE SECURED, SEALED AND INSULATED AS REQUIRED BY THE ENERGY MEASURES. |
| INSTALL WATERPROOF GYPSUM BOARD AT ALL WATER SPLASH AREAS TO MINIMUM 10" ABOVE SHOWER DRAINS. |
| INSULATE WASTE LINES FOR SOUND CONTROL. |

SITE NOTES

SITE INFORMATION PROVIDED BY COUNTY TAX MAP AND OWNER VERIFICATION. ALL SITE CONDITIONS TO BE VERIFIED PRIOR TO CONSTRUCTION.

ALL SETBACKS, EASEMENTS AND CG&R REQUIREMENTS TO BE VERIFIED PRIOR TO CONSTRUCTION.

FINAL SITING OF THE DWELLING SHALL BE THE SOLE RESPONSIBILITY OF THE CONTRACTOR.

ALL HARDSCAPE DRAINAGE TO BE DIRECTED TO LANDSCAPE DRAINAGE CONTAINMENT OR CITY DRYWELL. OR STORM WATER COLLECTION WHERE APPLICABLE.

CONFIRM ALL UTILITIES AND TRENCH LOCATIONS WITH CONTRACTOR PRIOR TO CONSTRUCTION.

PROVIDE EROSION CONTROL AND SILT FENCING AT PROJECT PERIMETER.

GRADING NOTES:

CONTRACTOR TO VERIFY LOCATION OF ALL EXISTING UTILITIES.

PROVIDE POSITIVE DRAINAGE AWAY FROM BUILDING.

FINAL GRADE TO CONVEY SURFACE DRAINAGE TOWARD ROCK CHANNELS AND DISPERSION TRENCHES.

DRAINAGE CONTAINMENT CALCULATIONS SHALL BE LISTED ON THE SITE DRAWINGS AND BASED ON LOCAL CODE.

AREAS TO BE FILLED SHALL BE CLEARED, GRUBBED TO REMOVE TREES, VEGETATION, ROOTS AND OTHER OBJECTIONABLE MATERIAL AND STRIPPED OF TOPSOIL.

PLACE FILL SLOPES WITH A GRADIENT STEEPER THAT 3:1 IN LIFTS NOT TO EXCEED 12 INCHES, AND MAKE SURE EACH LIFT IS PROPERLY COMPACTED.

FOUNDATION NOTES

ANCHOR BOLTS TO BE SPACED AT 48" O.C. MAX U.N.O ON SHEAR WALL PLAN.

ENGINEERED RETAINING WALLS MAY BE REQUIRED @ ALL LOCATIONS WHERE THE DISTANCE FROM FOOTING TO THE TOP OF THE MATERIAL BEING RETAINED IS EQUAL TO OR GREATER THAN 4' OR IF THERE IS A SURCHARGE ON THE WALL. (I.E.: SLOPING HILL, DRIVEWAY OR GARAGE SLAB ABOVE)

CONTRACTOR TO VERIFY PLAN TO ACTUAL SITE CONDITIONS AND CONTACT ENGINEER IF RETAINING WALLS ARE REQUIRED.

STEP FOOTING AND STEM WALL AS REQUIRED BY GRADE.

PROVIDE CLOSEABLE FOUNDATION VENTS (1 PER 150 SQ')

PROVIDE 6 MIL VAPOR BARRIER @ GRAWL SPACE.

TYP FOUNDATION WALL AT 1 STORY CONSTRUCTION TO BE 24"H X 6" CONC. WALL WITH (2) #4 BAR HORIZ. CONT. AND (1) #4 BAR VERT @ 48" O/C .

TYP FOUNDATION WALL AT 2 STORY CONSTRUCTION TO BE 24"H X 8" CONC. WALL WITH (2) #4 BAR HORIZ. CONT. AND (1) #4 BAR VERT @ 48" O/C .

FOR 36"H WALL PROVIDE (3) #4 BAR HORIZ. CONT. AND (1) #4 BAR VERT @ 24" O/C.
FOR 48"H WALL PROVIDE (4) #4 BAR HORIZ. CONT. AND (1) #4 BAR VERT @ 24" O/C.

TYP STRIP FOOTING AT 1 STORY FOUNDATION WALL TO BE 12"W X 6"D CONC FOOTING WITH (2) #4 BAR CONT.

TYP STRIP FOOTING AT 2 STORY FOUNDATION WALL TO BE 16"W X 8"D CONC FOOTING WITH (2) #4 BAR CONT.

FLOOR FRAMING NOTES

AT LOWER FLOOR USE 3/4" T&G PLYWOOD OR 3/4" EDGEGLD SUBFLOOR OVER 9 1/2" I JOISTS.

AT UPPER FLOOR USE 3/4" T&G PLYWOOD OR 3/4" EDGEGLD SUBFLOOR OVER 11 7/8" I JOISTS.

GLUE AND NAIL W/ 8D NAILS @ 6" O.C. EDGES & 12" FIELD U.N.O.

SEE MANUFACTURERS PLAN FOR SPACING & TYPE.

WHERE TOP OF FLOOR BEAMS ARE EVEN WITH TOP OF JOISTS PROVIDE APPROPRIATE SIMPSON TOP FLANGE OR FACE MOUNT HANGER.

NAIL RIM BOARD TO SILL PLATE @ 4" O.C. U.N.O. IN ENGINEERS CALCULATIONS

WALL FRAMING NOTES

STRUCTURAL CONNECTORS TO BE SIMPSON (OR EQ.) INSTALLED WITH MAX. NAILING. USE GALVANIZED NAILS WHERE EXPOSED TO WEATHER.

ALL EXTERIOR WALLS TO BE 2X6 #2 DF STUDS @ 16" O.C. W/ 7/16" O.S.B. OR SIM. INSTALLED W/ 8D NAILS @ 6" O.C. EDGES & 12" FIELD U.N.O.

ALL INTERIOR WALLS TO BE 2X4 #2 DF STUDS @ 16" O.C.

TYP. HEADER 4X8 #2 DF U.N.O.

TYP. HEADER BEARING SUPPORT- (1) 2X TRIMMER & (1) 2X KING STUD U.N.O. PLACE DBL TRIMMERS @ HEADERS OVER 10" IN DEPTH OR OPENINGS GREATER THAN 8" IN WIDTH.

PROVIDE FULL WIDTH 2X BEARING UNDER ALL BEAM SUPPORT POINTS TO FOUNDATION U.N.O.

REFERENCE PLANS FOR BEAM SIZES OR STRUCTURAL CONNECTIONS NOT DEFINED HERE.

REFERENCE PLANS FOR ADDITIONAL ENGINEERS SPECIFICATIONS.

ALL FRAMING AND FASTENING SHALL COMPLY TO THE MOST CURRENT LOCAL BUILDING CODES.

ROOF FRAMING NOTES

TYP. ROOF FRAMING WILL BE MANUFACTURED TRUSSES @ 24" O.C. OR #2 D.F. RAFTERS @ 24" O.C. (U.N.O)

TYP HEADER TO BE 4X8 6DF UNO ON HEADER SCHEDULE.

TRUSS MANUFACTURER TO PROVIDE ALL DRAWINGS AND ENGINEERING FOR TRUSSES.

TRUSS MANUFACTURER TO SPECIFY ALL CONNECTIONS AND HANGERS.

INSTALL ALL PERMANENT BRACING AS PER ENGINEERED TRUSSES DRAWINGS.

OVERFRAME IN DESIGNATED AREAS W/ 2X6 #2 D.F. (SUPPORT TO MAIN ROOF FRAMING @ 48" O.C. MAX.)

SHEATHING TO BE 5/8" OSB OR EQ. NAILED @ 6" EDGES & 12" FIELD.

PROVIDE 2 COURSES OF ICE DAM PROTECTION MIN AT ROOF PERIMETER

30# ROOFING FELT & STANDING SEAM METAL ROOFING.

PROVIDE ROOF VENTING PER CODE.

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DOOR AND WINDOW NOTES:

BASEMENTS AND EVERY BEDROOM SHALL BE PROVIDED WITH AN EGRESS WINDOW. FINISH SILL HEIGHT SHALL NOT BE GREATER THAN 44" ABOVE THE FINISH FLOOR HEIGHT AND SHALL HAVE A MINIMUM OPENABLE AREA OF 5.7 SQ. FT. AT UPPER FLOOR LEVELS. EGRESS WINDOWS AT GRADE FLOOR SHALL HAVE A MINIMUM OPENABLE AREA OF 5.0 SQ.FT. EGRESS WINDOWS SHALL NOT HAVE AN OPENABLE AREA LESS THAN 20" WIDE OR 24" HIGH.

OPERABLE WINDOWS INSTALLED WHERE THE SILL IS LESS THAN 24" ABOVE FINISH FLOOR INTERIOR AND GREATER THAN 12" ABOVE GRADE OR OTHER SURFACE SHALL HAVE AN APPROVED WINDOW OPENING CONTROL DEVICE (W/OC) OR SIMILAR.

WINDOWS IN HAZARDOUS LOCATIONS PER R308.4 SHALL HAVE SAFETY GLAZING PER R308.1

INTERIOR DOORS SHALL BE PAINTED OR STAINED. ENTRY DOOR TO BE DEFINED BY HOME OWNER PRIOR ORDERING

DOORS BETWEEN GARAGE AND LIVING AREA SHALL BE 1-3/4" TIGHT FITTING SOLID CORE DOORS WITH A RATING OF 20 MINUTES.

AT LEAST ONE EXTERIOR EXIT DOOR WILL BE 36" MIN. NET CLEAR DOORWAY SHALL BE 32" MIN. DOOR SHALL BE OPENABLE FROM INSIDE WITHOUT THE USE OF A KEY OR ANY SPECIAL KNOWLEDGE OR EFFORT. GLAZING IN DOORS SHALL BE DUAL PANE SAFETY GLASS WITH MIN. U-VALUE OF 0.60

GARAGE DOORS TO BE SECTIONAL, OVERHEAD DOORS

RAILING NOTES:

STAIRWAYS SHALL HAVE A MIN. WIDTH OF 34". HAND RAILS MAY ENCR OACH A MAX. OF 3 1/2" INTO THE REQUIRED WIDTH.

TREADS SHALL HAVE A MIN. WIDTH OF 9". STAIR TREADS MUST BE UNIFORM AND CAN NOT VARY FROM THE LARGEST TO THE SMALLEST BY MORE THAN 3/8".

STAIRWAYS SHALL HAVE MIN. 6'-8" OF HEADROOM AT THE NOSE OF THE STAIR.

ENCLOSED USABLE SPACE UNDER INTERIOR STAIRS SHALL BE PROTECTED ON THE ENCLOSED FACE WITH 5/8" TYPE "X" GYPSUM WALL BOARD.

STAIRWAYS SHALL HAVE AT LEAST ONE HANDRAIL LOCATED 34" TO 38" ABOVE THE NOSING OF TREADS AND LANDINGS. THE HAND GRIP PORTION OF HANDRAILS SHALL NOT BE LESS THAN 1-1/2" OR GREATER THAN 2" IN CROSS-SECTIONAL DIMENSION.

HANDRAILS SHALL BE CONTINUOUS THE FULL LENGTH OF THE STAIRS. THE ENDS OF HANDRAILS SHALL RETURN TO WALL OR TERMINATE INTO A NEWEL POST OR SAFETY TERMINAL.

STAIRWAYS HAVING LESS THAN 2 RISERS DO NOT REQUIRE A HAND RAIL.

36" MIN. HEIGHT GUARDRAILS SHALL BE PROVIDED FOR AT PORCHES, DECKS, BALCONIES, STAIRWAYS AND LANDINGS WHERE THE ADJACENT SURFACE IS GREATER THAN 30" BELOW.

RAILING AND GUARDRAIL BALUSTER SPACING SHALL BE NO GREATER THAN 4".

THE TRIANGULAR OPENINGS FORMED BY THE RISER, TREAD, AND BOTTOM OF GUARDRAIL SHALL NOT ALLOW A 6" DIAMETER SPHERE TO PASS THROUGH.

EXTERIOR SPIRAL STAIRS TO BE FABRICATED AND INSTALLED PER THE MFG. INSTRUCTIONS.

ELECTRICAL, DATA, & AUDIO NOTES:

HOME OWNER SHALL DO A WALK-THRU WITH RELEVANT INSTALLERS TO VERIFY THE EXACT LOCATION FOR OUTLETS, LIGHTS, SWITCHES, CABLE, DATA, PHONE, AUDIO, ETC.

ELECTRICAL NOTES:

- ELECTRICAL RECEPTACLES IN BATHROOMS, KITCHENS AND GARAGES SHALL BE G.F.I. OR G.F.I.C. PER NATIONAL ELECTRICAL CODE REQUIREMENTS.
- PROVIDE ONE SMOKE DETECTOR IN EACH ROOM AND ONE SMOKE / CARBON MONOXIDE DETECTOR IN EACH CORRIDOR ACCESSING BEDROOMS WITHIN 15 FEET. CONNECT SMOKE DETECTORS TO HOUSE POWER AND INTER-CONNECT SMOKE DETECTORS SO THAT, WHEN ANY ONE IS TRIPPED, THEY ALL WILL SOUND. PROVIDE BATTERY BACKUP FOR ALL UNITS. (SEE R314 & R315)
- CIRCUITS SHALL BE VERIFIED WITH HOME OWNER PRIOR TO WIRE INSTALLATION.
- FINAL SWITCHES FOR TIMERS AND DIMMERS SHALL BE VERIFIED WITH HOME OWNER.
- FIXTURES TO BE SELECTED BY HOME OWNER.

AUDIO:

- LOCATE SPEAKERS AND AUDIO CONTROLS AS INDICATED IN THE PLAN; RUN CIRCUIT OF SPEAKER WIRING TO AUDIO HOME PANEL SPECIFIED BY FLOOR.
- AUDIO SPEAKERS TO BE APPROVED BY HOME OWNER.
- LOCATE JACKS AS INDICATED IN THE PLAN; INSTALL DATA / CABLE PANEL SIMILAR TO "ON Q". SYSTEM TO BE APPROVED BY HOME OWNER.

DATA / CABLE:

LOCATE SECURITY PANELS AS INDICATED IN THE PLAN; SYSTEM TO BE APPROVED BY HOME OWNER.

| NUMBER | DATE | REV | BY | REVISION TABLE DESCRIPTION |
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| PROJECT LOCATION: ROLIN RESIDENCE LOT 13 RIVER MEADOWS BEND OR, 97107 |
| PROJECT FOR: SIENNA BUILDING COMPANY STEVE MCDOWELL 541-241-0406 |

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| RESIDENTIAL CONSTRUCTION AND DESIGN | FO BOX T161 541-280-1120 PH 541-610-1744 FAX CG# 165287 |
| Pittleton Inc. | |

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| DATE: |
| 1/6/2017 |
| SCALE: |
| 1/4"=1' U.N.O. |
| SHEET TITLE: PLAN NOTES |
| SHEET: |
| A0.02 |

RESERVED FOR BUILDING
DEPARTMENT STAMP

| NUMBER | DATE | REV BY | DESCRIPTION |
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PROJECT LOCATION:
ROLIN RESIDENCE
LOT 13 RIVER MEADOWS
BEND OR, 97107

PROJECT FOR:
SIENNA BUILDING COMPANY
STEVE McDOWELL
541-241-0406

RESIDENTIAL CONSTRUCTION
AND DESIGN
FO BOX 1167
541-280-1120 PH
541-610-1744 FAX
CGB# 165287

ROBERT
PITTLTON INC.

DATE:

1/6/2017

SCALE:

1/4"=1' U.N.O.

SHEET TITLE:
SITE PLAN

SHEET:
A1.01

LEGEN

- D**
- FOUND 5/8" IRON ROD WITH YELLOW PLASTIC CAPSTAMPED "SGE&S"
 - (R) BEARING & DISTANCE PER PLAT OF "RIVER MEADOWS" BY MICHAEL TYE, FILED 01/25/1990 AS CS09342
 - (M) MEASURED BEARING & DISTANCE FENCING- NONE PROPOSED

- PONDEROSA PINE TREE & DIAMETER
- LODGEPOLE PINE TREE & DIAMETER
- PONDEROSA PINE TREE & DIAMETER- TO BE REMOVED (0)
- LODGEPOLE PINE TREE & DIAMETER- TO BE REMOVED (23)

- WATER
- METER
- POWER
- PEDESTAL
- SEWER
- VALVE
- FUBLIC UTILITY EASEMENT

REGISTERED
PROFESSIONAL
LAND SURVEYOR

OREGON
JULY 26, 1989
JAMES D. PERRY
2 4 0 7
RENEWES 12-31-2016

SURVEYORS NOTES:

THIS SURVEY IS FOR TOPOGRAPHIC PURPOSES ONLY AND DOES NOT MEET THE REQUIREMENTS OF A BOUNDARY SURVEY AND IS SUBJECT TO ANY INACCURACIES THAT A SUBSEQUENT BOUNDARY SURVEY MAY REVEAL.

CONTOURS ARE BASED ON AN ASSUMED DATUM AND HAVE NO RELATIONSHIP TO SEA LEVEL DATUM.

THIS PROPERTY IS SUBJECT TO ALL EASEMENTS, RESTRICTIONS, AND RIGHTS-OF-WAY OF RECORD AND THOSE BUILDING LOT COVERAGE AND CALCULATIONS:

LOT AREA= 14,424 SQ.FT
ALLOWABLE LOT COVERAGE 30% ARC COMPLIANCE= 4327 SQ.FT.
PROPOSED BUILDING COVERAGE = 3555 SQ. FT. = 24.64%

IMPERVIOUS AREA:

DRIVEWAY= 1243 SQ.FT.
WALKWAY= 130 SQ.FT.
ROOF AREA= 4202 SQ.FT.

TOTAL= 5575 SQ.FT.
38.65% OF LOT

SITE CONSTRUCTION NOTES:


- PRIOR TO CONSTRUCTION ALL GRADE AND TREE PROTECTION AREAS ARE TO BE IDENTIFIED AND APPROPRIATE PROTECTION MEASURES (IE. FENCING, STRAW BALES, ETC.) SHALL BE IN PLACE.
- DURING EXCAVATION AND PROJECT CONSTRUCTION, EROSION IS TO BE MINIMIZED AND ALL RUNOFF IS TO BE CONTAINED ON-SITE.
- SILT FENCING AND/OR BIO-BAGS SHALL BE PLACED AT THE BASE OF SLOPES AND CUTS TO PREVENT RUN-OFF FROM ENCROACHING ONTO COMMON AREAS OR ADJACENT PARCELS.
- EXCAVATED, OR OTHERWISE DISTURBED AREAS, ARE TO BE WATERED TO PROVIDE DUST CONTROL.
- ALL MATERIALS NOT TO BE USED IN BACKFILL, LANDSCAPE, OR OTHER SITE REPAIR AND FINAL GRADING TO BE REMOVED AS SOON AS PRACTICAL.
- EQUIPMENT AND MATERIALS STAGING SHALL BE CONTAINED IN LOCATIONS SHOWN ON THE CONSTRUCTION SITE PLAN, OR AREAS OTHERWISE ESTABLISHED BY THE ARC OR OWNERS ASSOCIATION.
- CONSTRUCTION PARKING SHALL BE CONTAINED ON SITE TO THE MOST PRACTICAL LIMITS.
- WHEN ON-STREET CONSTRUCTION PARKING IS REQUIRED ALL EFFORTS SHALL BE MADE TO MINIMIZE THE IMPACT ON THE FLOW OF TRAFFIC. IN NO CIRCUMSTANCES SHALL PARKING BE ALLOWED IN AREAS THAT PROHIBIT ACCESS TO COMMON AREAS OR ADJACENT PARCELS.
- ANY DIRT, MUD OR OTHER SPOILS THAT ARE TRACKED ONTO THE ROADWAYS SHALL BE CLEANED BY THE END OF THE SAME WORK DAY.
- ALL EFFORTS SHALL BE MADE TO KEEP THE CONSTRUCTION AREA CLEAN AND FREE OF TRASH AND DEBRIS. TRASH AND DEBRIS SHOULD BE REMOVED ON A WEEKLY BASIS.
- CONSTRUCTION PERSONNEL SHALL CONDUCT THEMSELVES IN A PROFESSIONAL MANNER AND ABIDE BY ANY AND ALL REGULATIONS SET BY THE ARC OR OWNERS ASSOCIATION.

GRADING AND DRAINAGE NOTES:

- CONTRACTOR TO VERIFY LOCATION OF ALL EXISTING UTILITIES.
- PROVIDE POSITIVE DRAINAGE AWAY FROM BUILDING.
- FINAL GRADE TO CONVEY SURFACE DRAINAGE TOWARD ROCK CHANNELS AND DISPERSION TRENCHES.
- DRAINAGE CONTAINMENT CALCULATIONS SHALL BE LISTED ON THE SITE DRAWINGS AND BASED ON LOCAL CODE.
- AREAS TO BE FILLED SHALL BE CLEARED, GRUBBED TO REMOVE TREES, VEGETATION, ROOTS AND OTHER OBJECTIONABLE MATERIAL AND STRIPPED OF TOPSOIL.
- PLACE FILL SLOPES WITH A GRADIENT STEEPER THAT 3:1 IN LIFTS NOT TO EXCEED 12 INCHES, AND MAKE SURE EACH LIFT IS PROPERLY COMPACTED.
- ALL SURFACE WATER AND RUNOFF TO BE CONTAINED ON SITE.
- VERIFY FLOW FROM HARDSCAPE TO DRAINAGE RETENTION AREAS.
- DRAINAGE RETENTION SHALL BE LINED WITH FILTER FABRIC OR APPROVED EQ AND FREE DRAINING RIVER ROCK TO BLEND WITH SURROUNDING LANDSCAPE ELEMENTS.
- PIPE ROOF RUNOFF FROM DOWNSPOUTS OR CHAINS TO RETENTION AREAS SO THAT RUNOFF DOES NOT ERODE FINISH GRADE AT EAVE.
- FINAL GRADING SHALL ALLOW FOR A MINIMUM OF 6" OF FLOW WITHIN THE FIRST 10'-0" UNLESS LIMITED PER SITE CONDITIONS.

SITE PLAN 1"=10'

RESERVED FOR BUILDING
DEPARTMENT STAMP

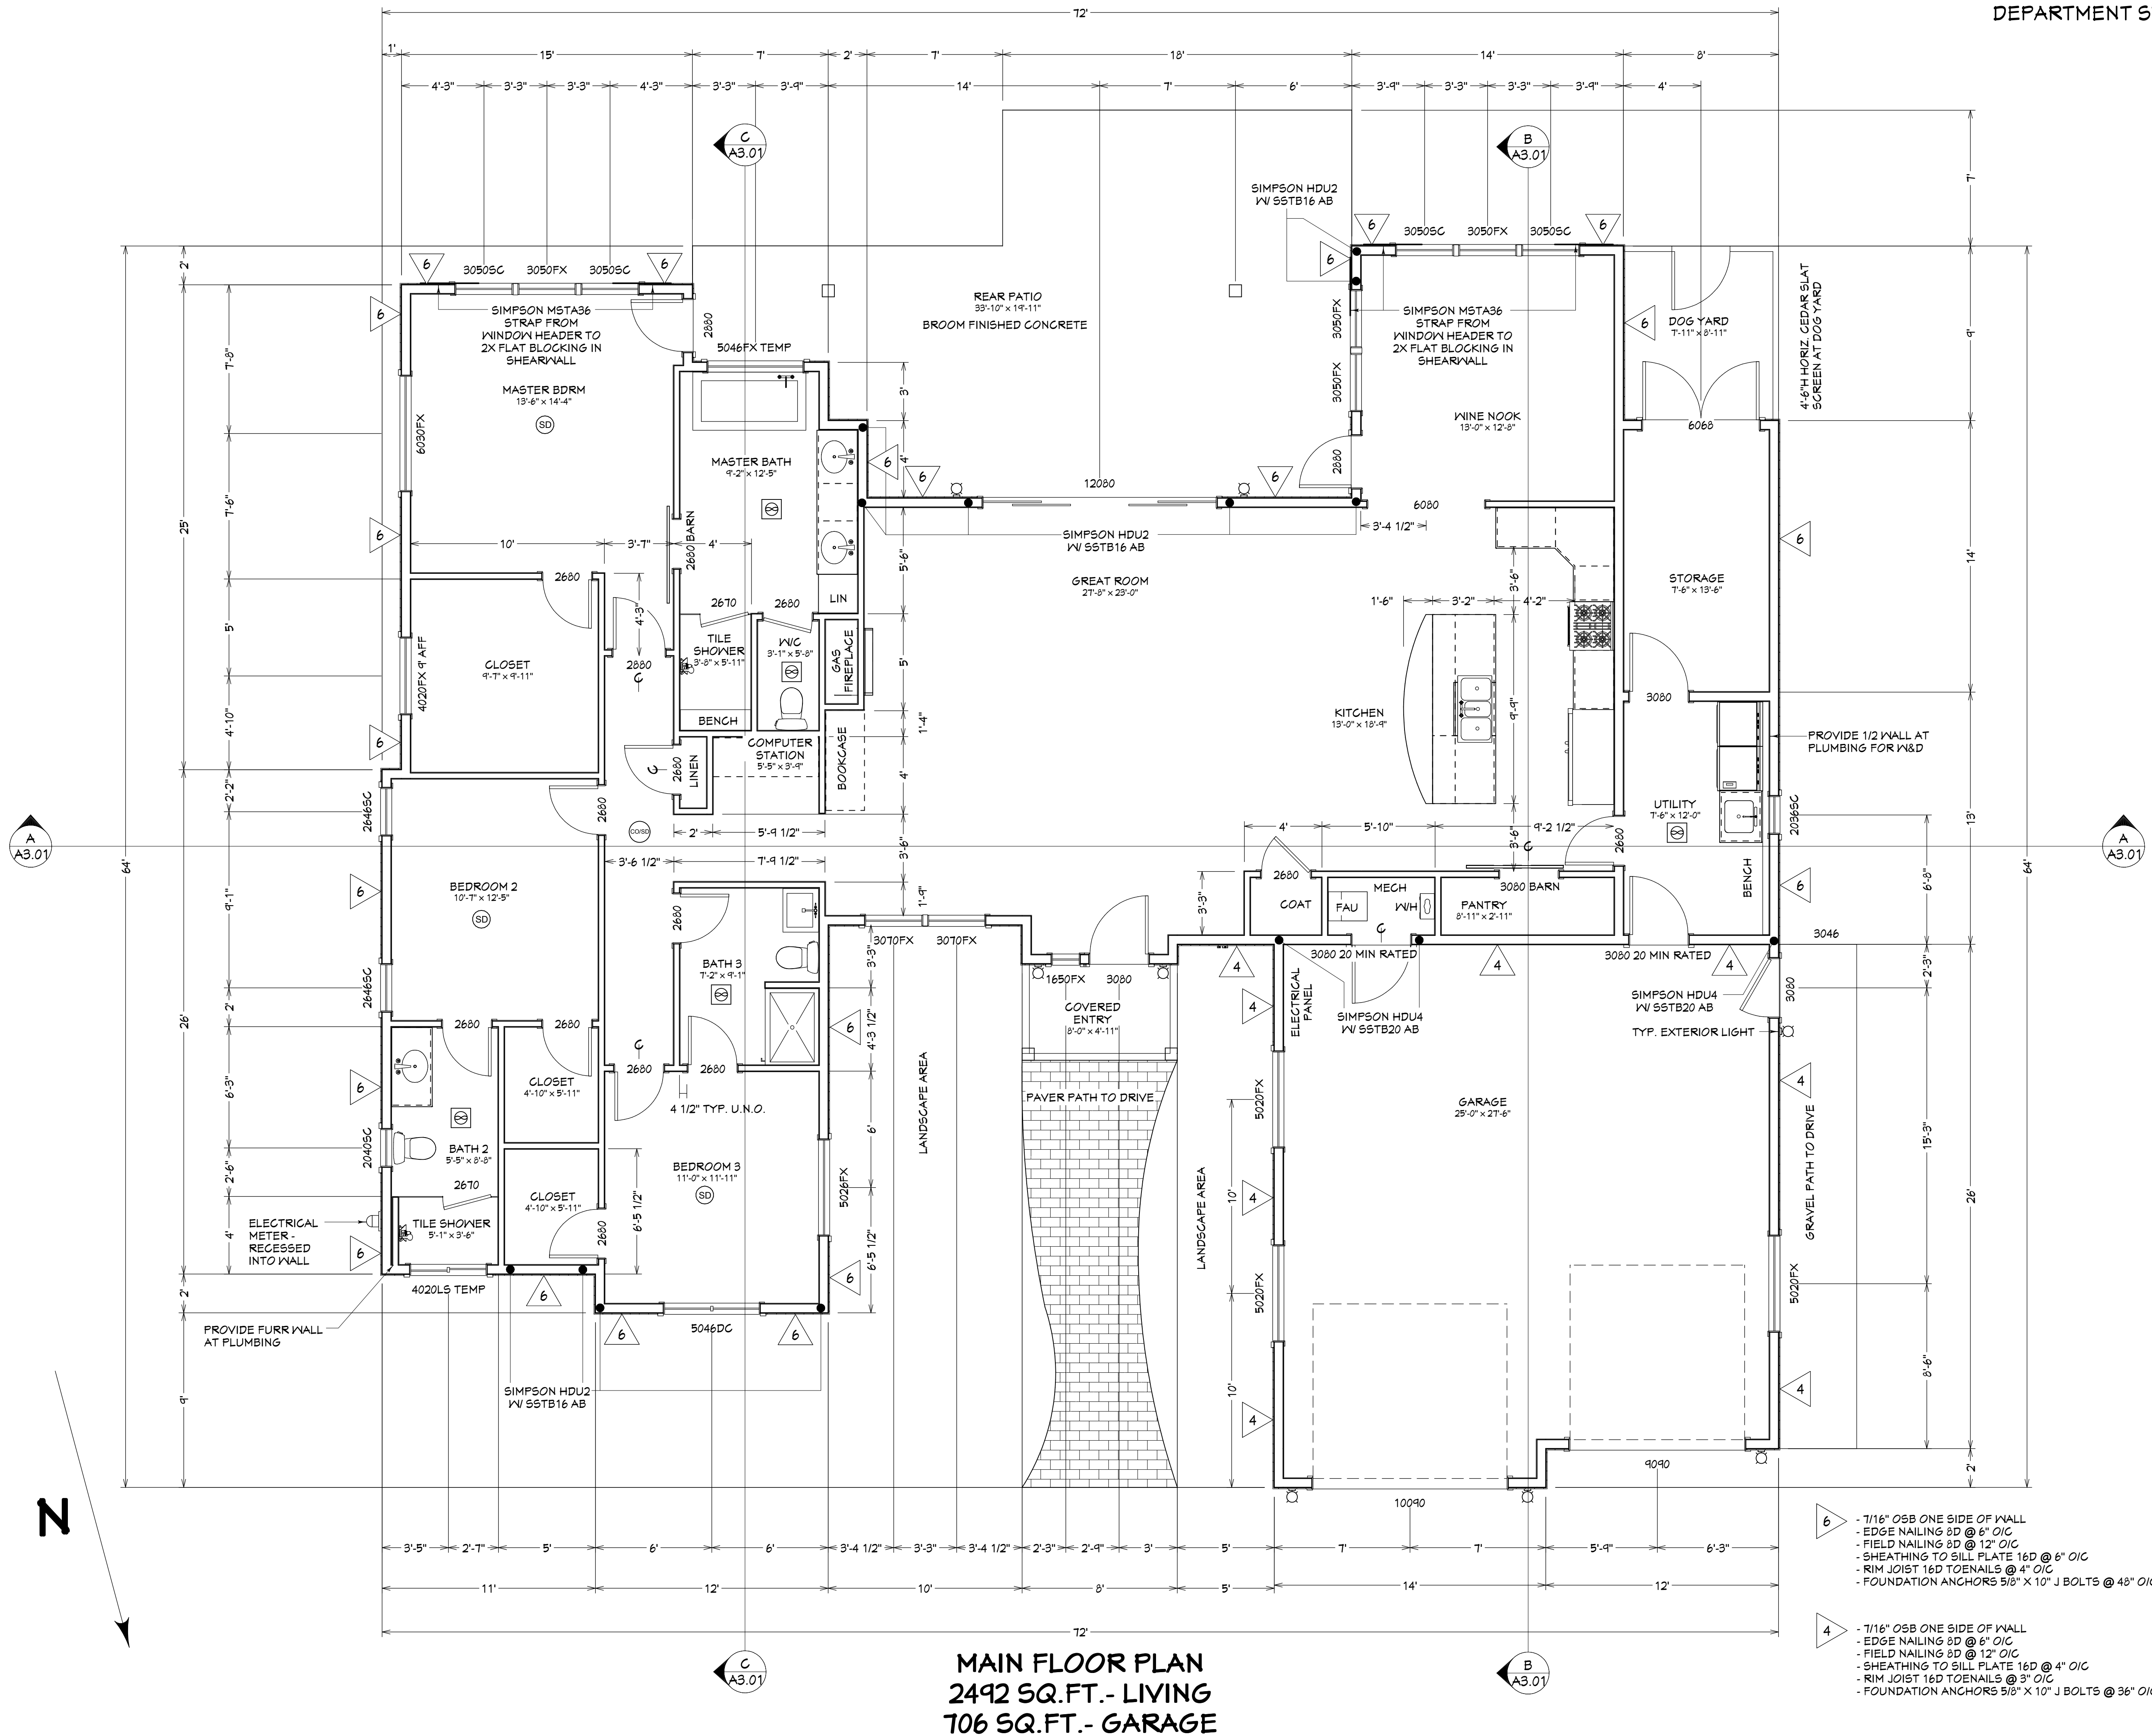

MAIN FLOOR PLAN
2492 SQ.FT.- LIVING
706 SQ.FT.- GARAGE

- 6 - 7/16" OSB ONE SIDE OF WALL
- EDGE NAILING 8D @ 6" O/C
- FIELD NAILING 8D @ 12" O/C
- SHEATHING TO SILL PLATE 16D @ 6" O/C
- RIM JOIST 16D TOENAILS @ 4" O/C
- FOUNDATION ANCHORS 5/8" X 10" J BOLTS @ 48" O/C
- 4 - 7/16" OSB ONE SIDE OF WALL
- EDGE NAILING 8D @ 6" O/C
- FIELD NAILING 8D @ 12" O/C
- SHEATHING TO SILL PLATE 16D @ 4" O/C
- RIM JOIST 16D TOENAILS @ 3" O/C
- FOUNDATION ANCHORS 5/8" X 10" J BOLTS @ 36" O/C

| REVISION TABLE | |
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| NUMBER | DESCRIPTION |
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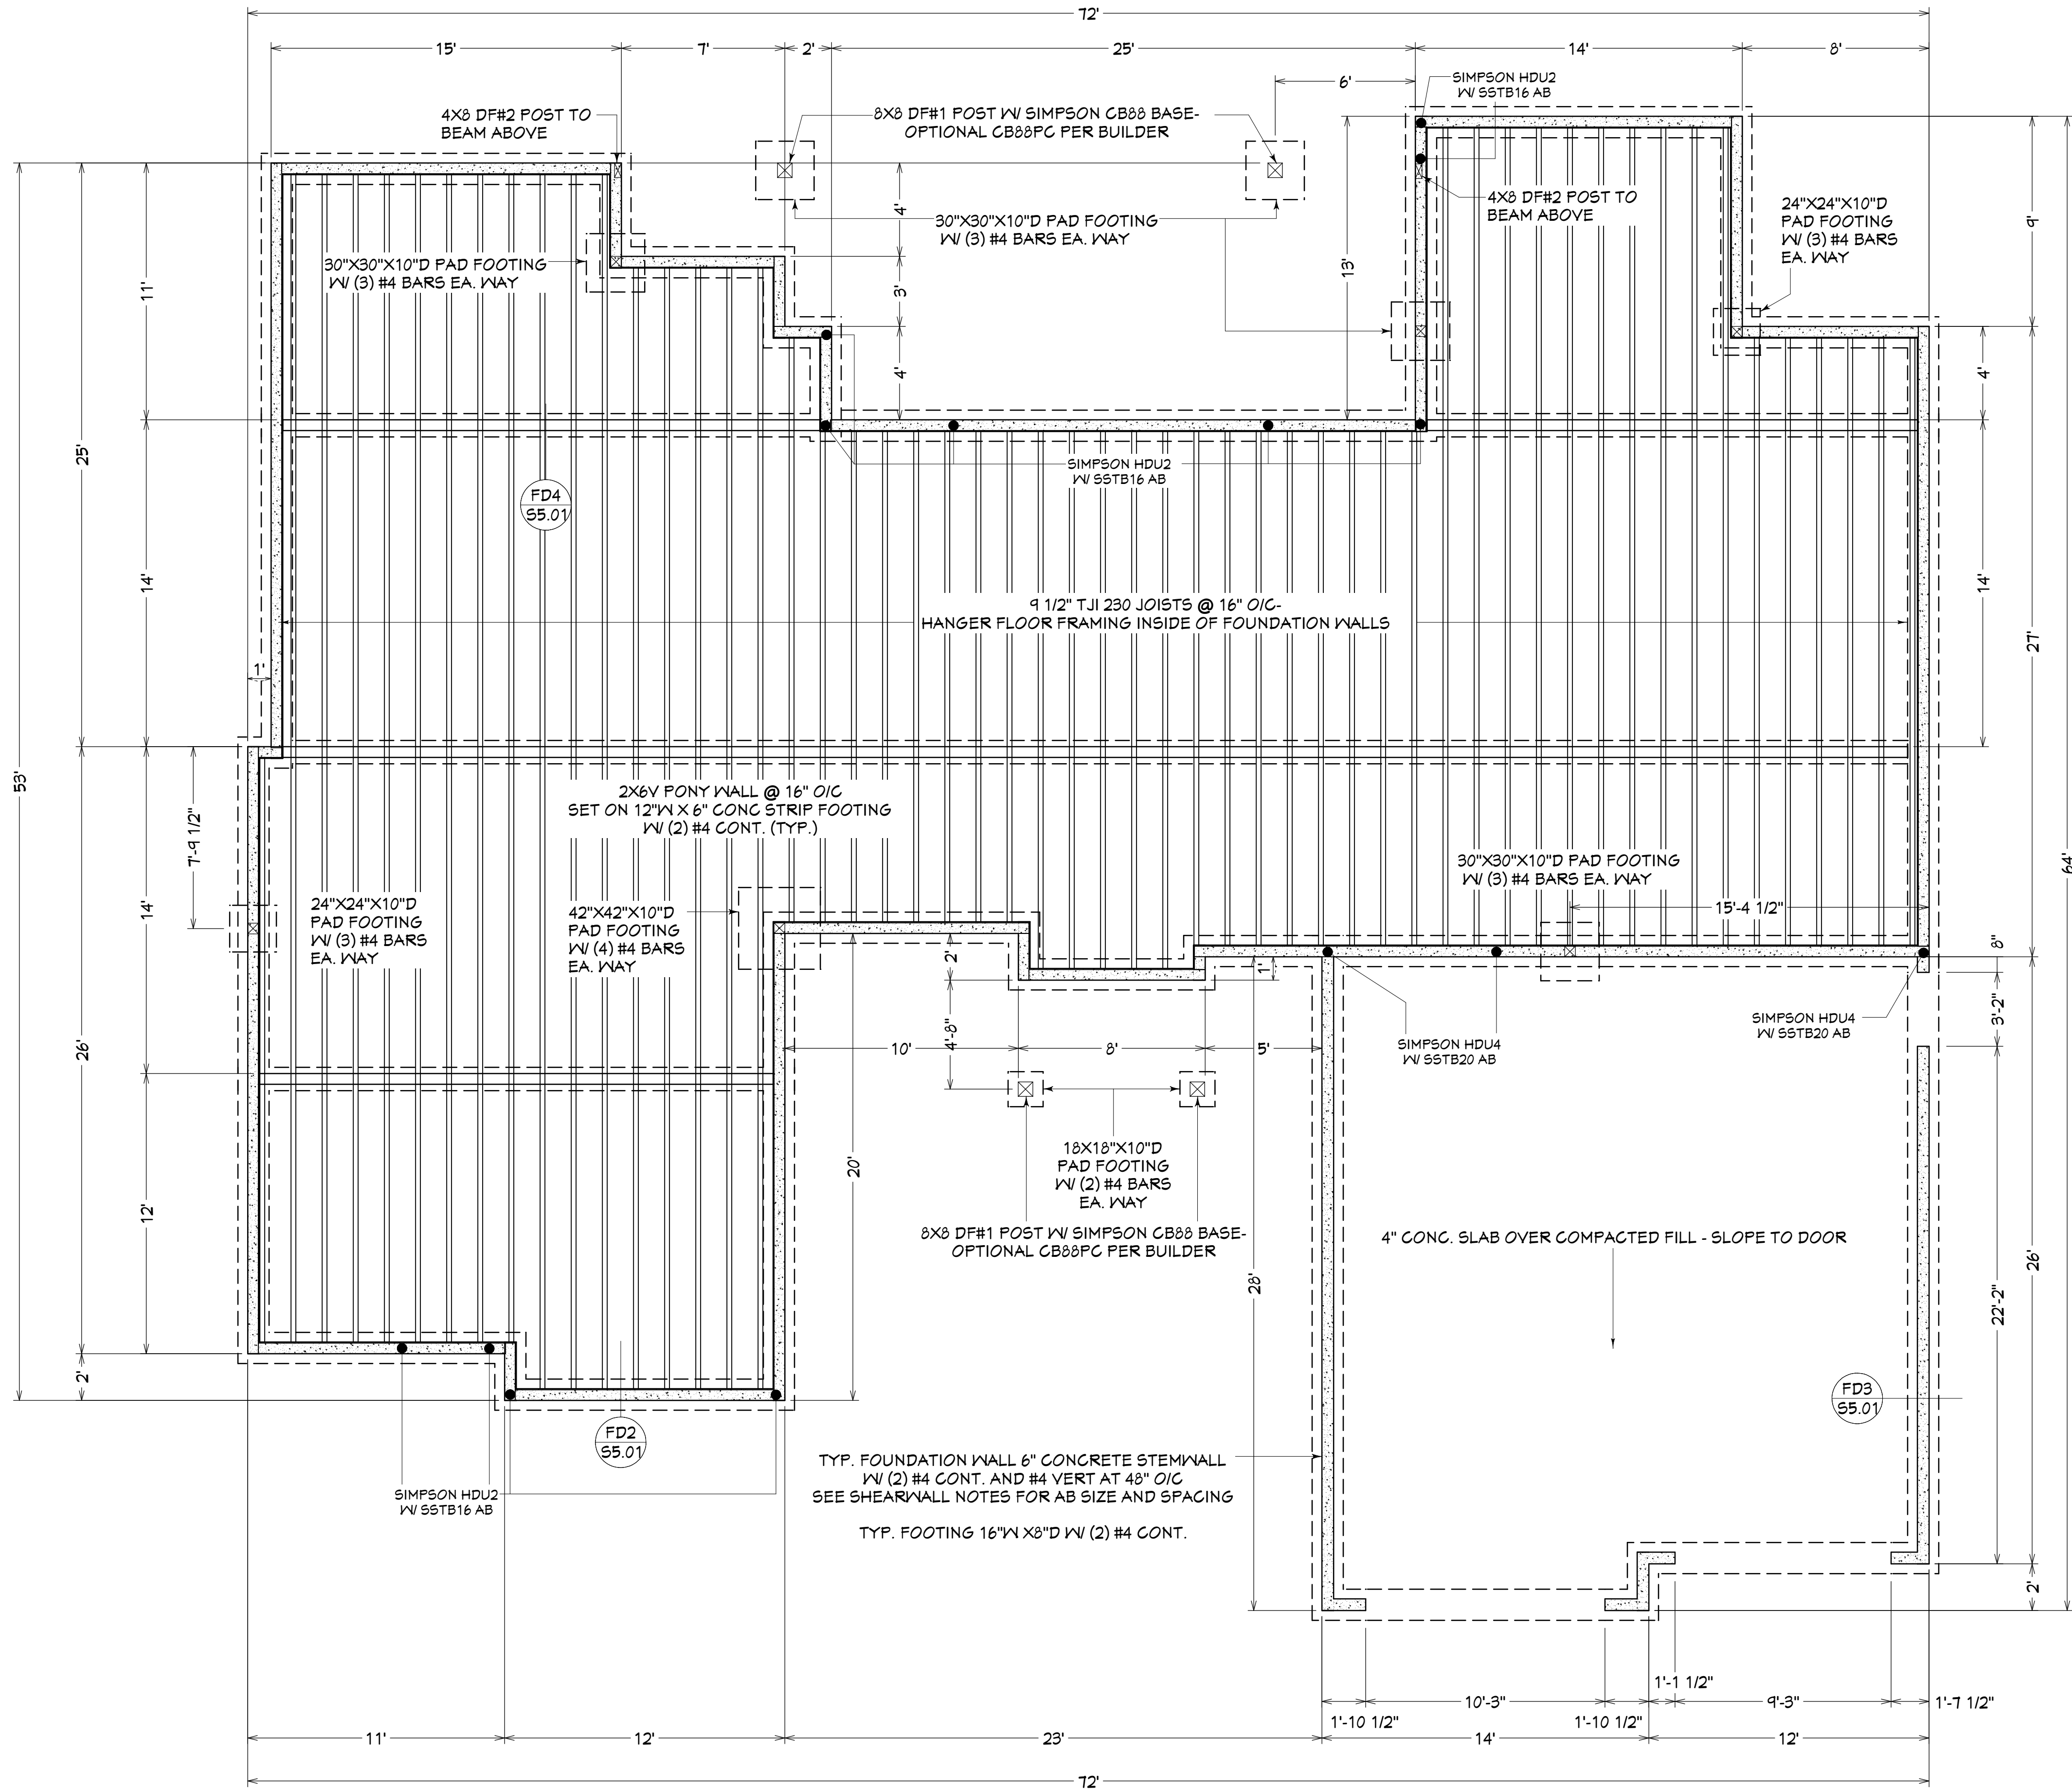
PROJECT LOCATION:
ROLIN RESIDENCE
LOT 13 RIVER MEADOWS
BEND OR, 97107

PROJECT FOR:
SIENNA BUILDING COMPANY
STEVE McDOWELL
541-241-0406

RESIDENTIAL CONSTRUCTION
AND DESIGN
541-280-1120 PH
541-510-1744 FAX
FO BOX 1167
BEND OR, 97709
CGB# 165287

ROBERT
LITTLETON INC.

| |
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| DATE: |
| 1/6/2017 |
| SCALE: |
| 1/4"=1' U.N.O. |
| SHEET TITLE: |
| MAIN FLOOR PLAN |
| SHEET: |
| A1.02 |



FOUNDATION AND FLOOR FRAMING PLAN

| REVISION TABLE | | DESCRIPTION | |
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| NUMBER | DATE | REV BY | DESCRIPTION |
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PROJECT LOCATION:
ROLIN RESIDENCE
LOT 13 RIVER MEADOWS
BEND OR, 97107

PROJECT FOR:
SIENNA BUILDING COMPANY
STEVIE McDOWELL
541-241-0406

RESIDENTIAL CONSTRUCTION
AND DESIGN
541-280-1120 PH
541-610-1744 FAX
FO BOX 1167
BEND OR, 97708
CGB# 165287

ROBERT
PITTLTON INC.

DATE:

1/6/2017

SCALE:


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SHEET TITLE:
FOUNDATION
AND FLOOR
FRAMING

SHEET:

A1.03

RESERVED FOR BUILDING
DEPARTMENT STAMP

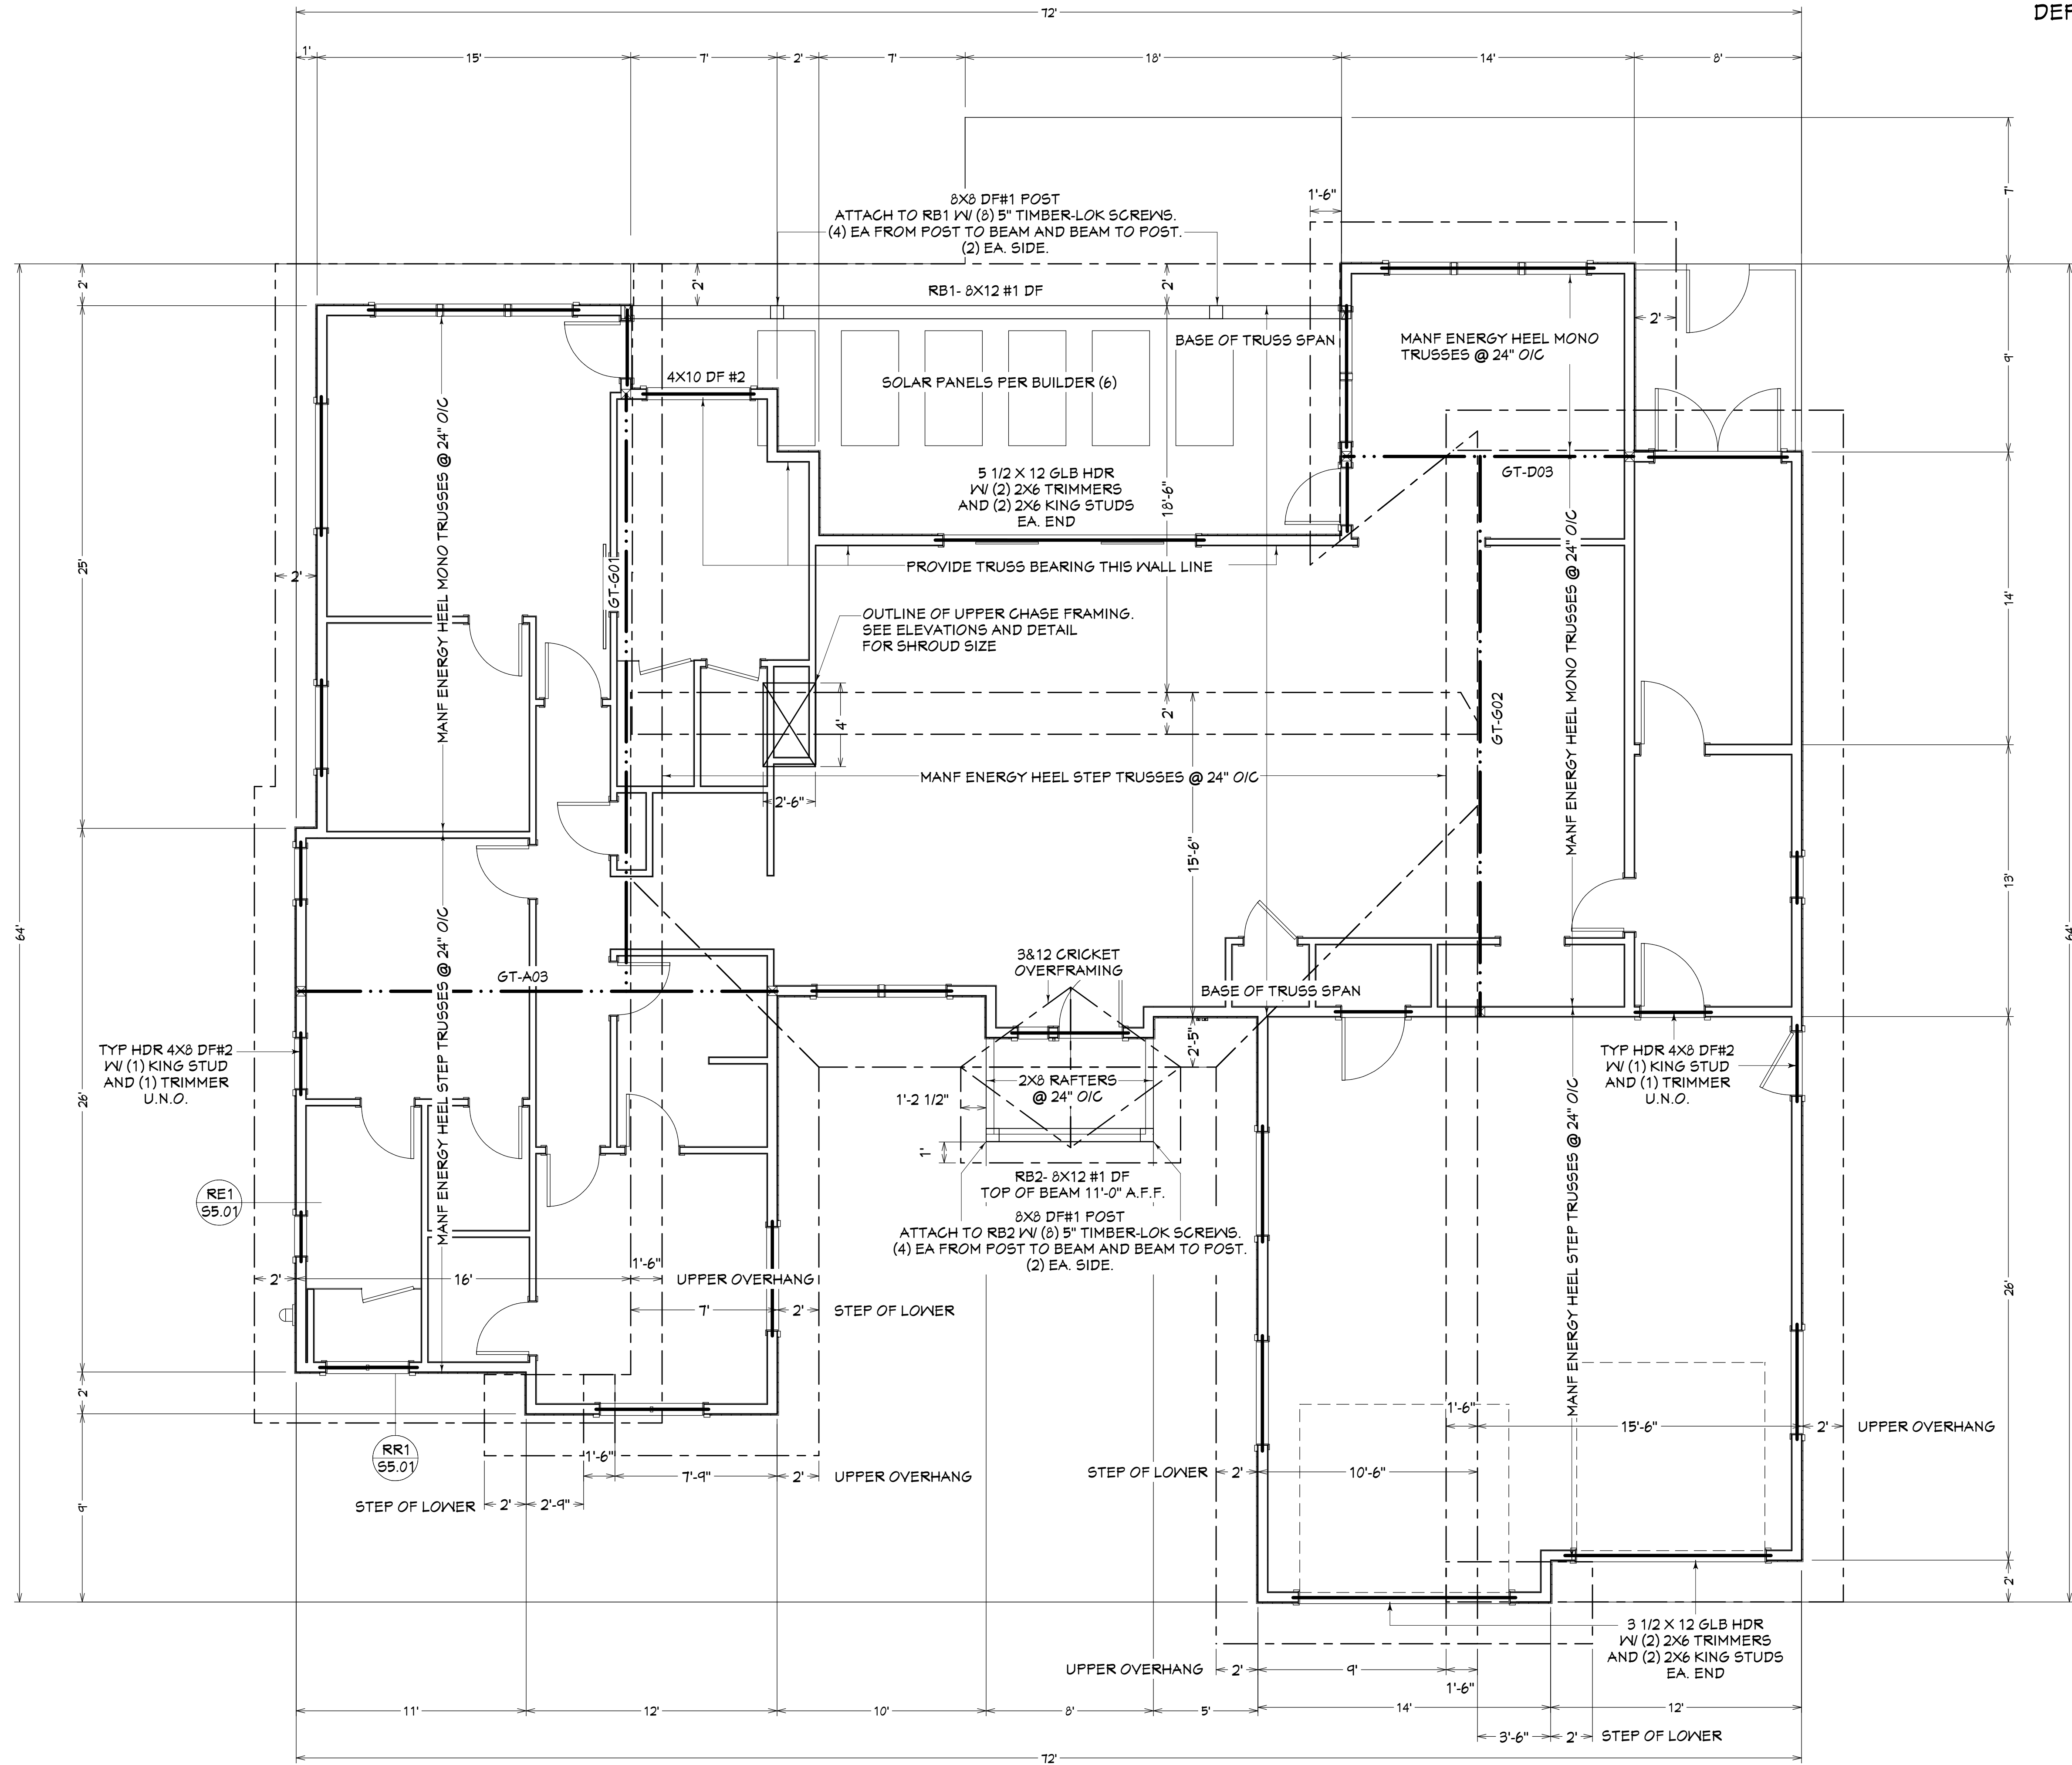

ROOF FRAMING PLAN

| REVISION TABLE | |
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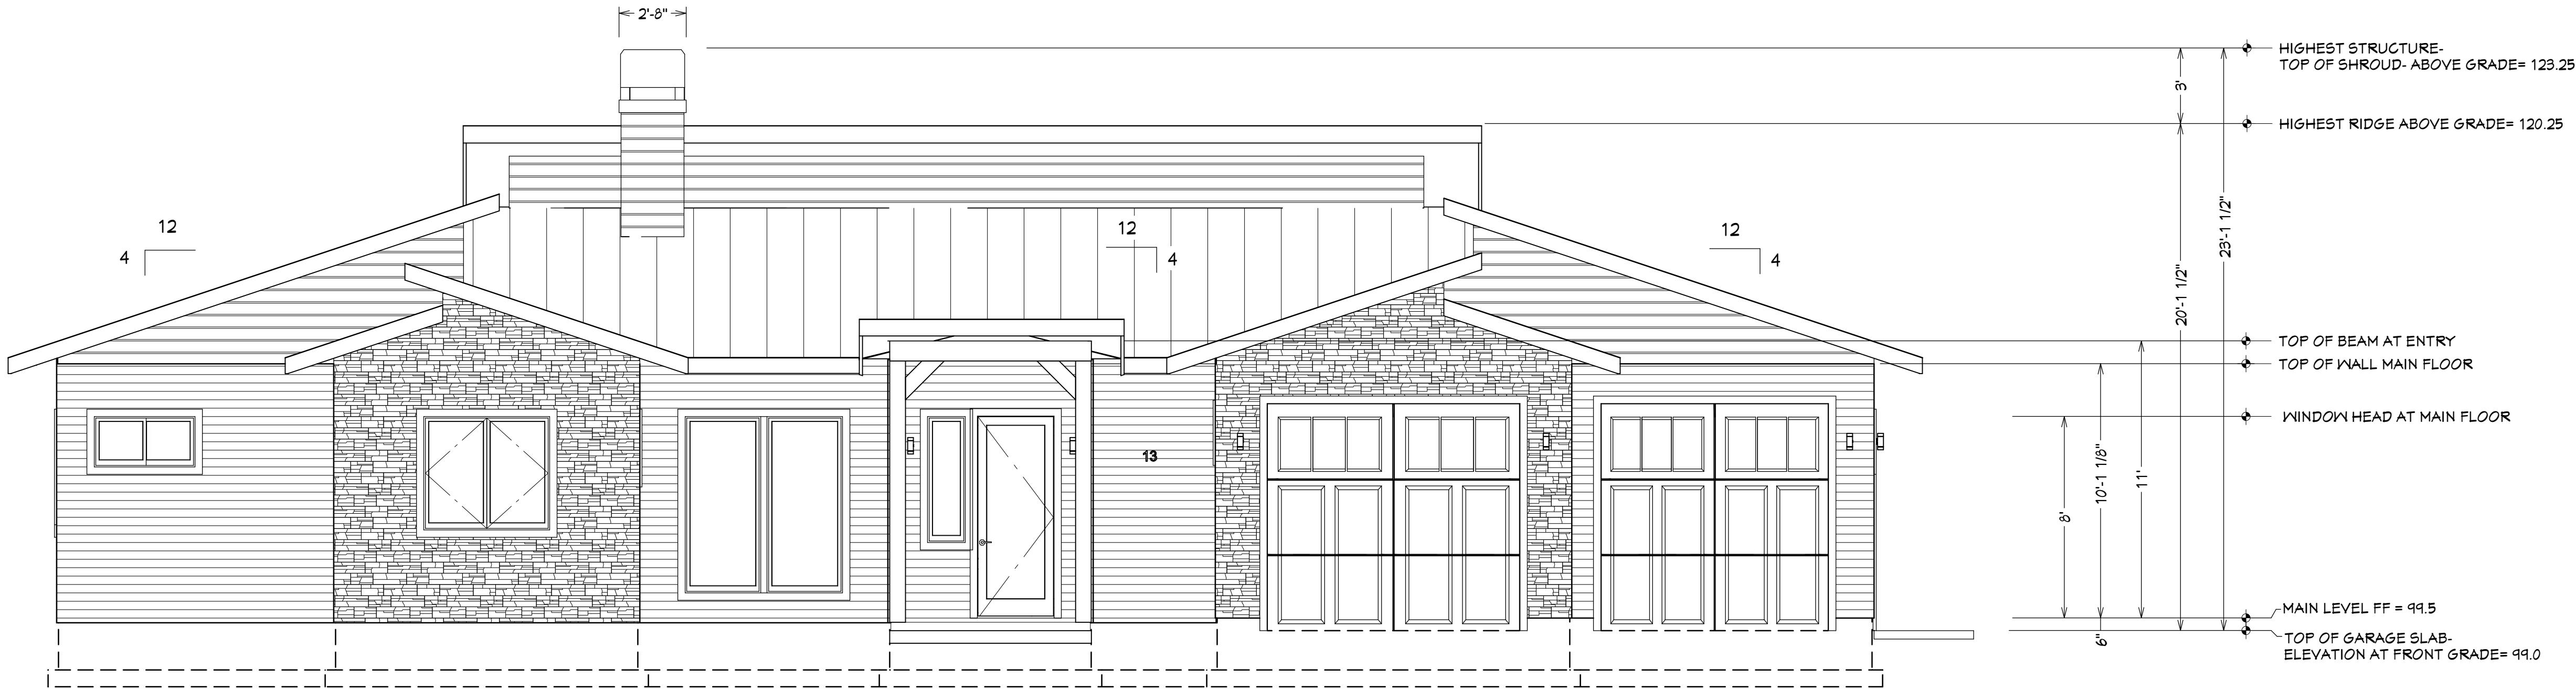
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ROLIN RESIDENCE
LOT 13 RIVER MEADOWS
BEND OR 97107

PROJECT FOR:
SIENNA BUILDING COMPANY
STEVE MCDONNELL
541-241-0406


RESIDENTIAL CONSTRUCTION
AND DESIGN
541-280-1120 PH
541-510-1744 FAX
FO BOX 1167
BEND OR 97708
CGB# 165287



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| DATE: |
| 1/6/2017 |
| SCALE: |
| 1/4"=1' U.N.O. |
| SHEET TITLE: |
| ROOF FRAMING PLAN |
| SHEET: |
| A1.04 |



FRONT ELEVATION

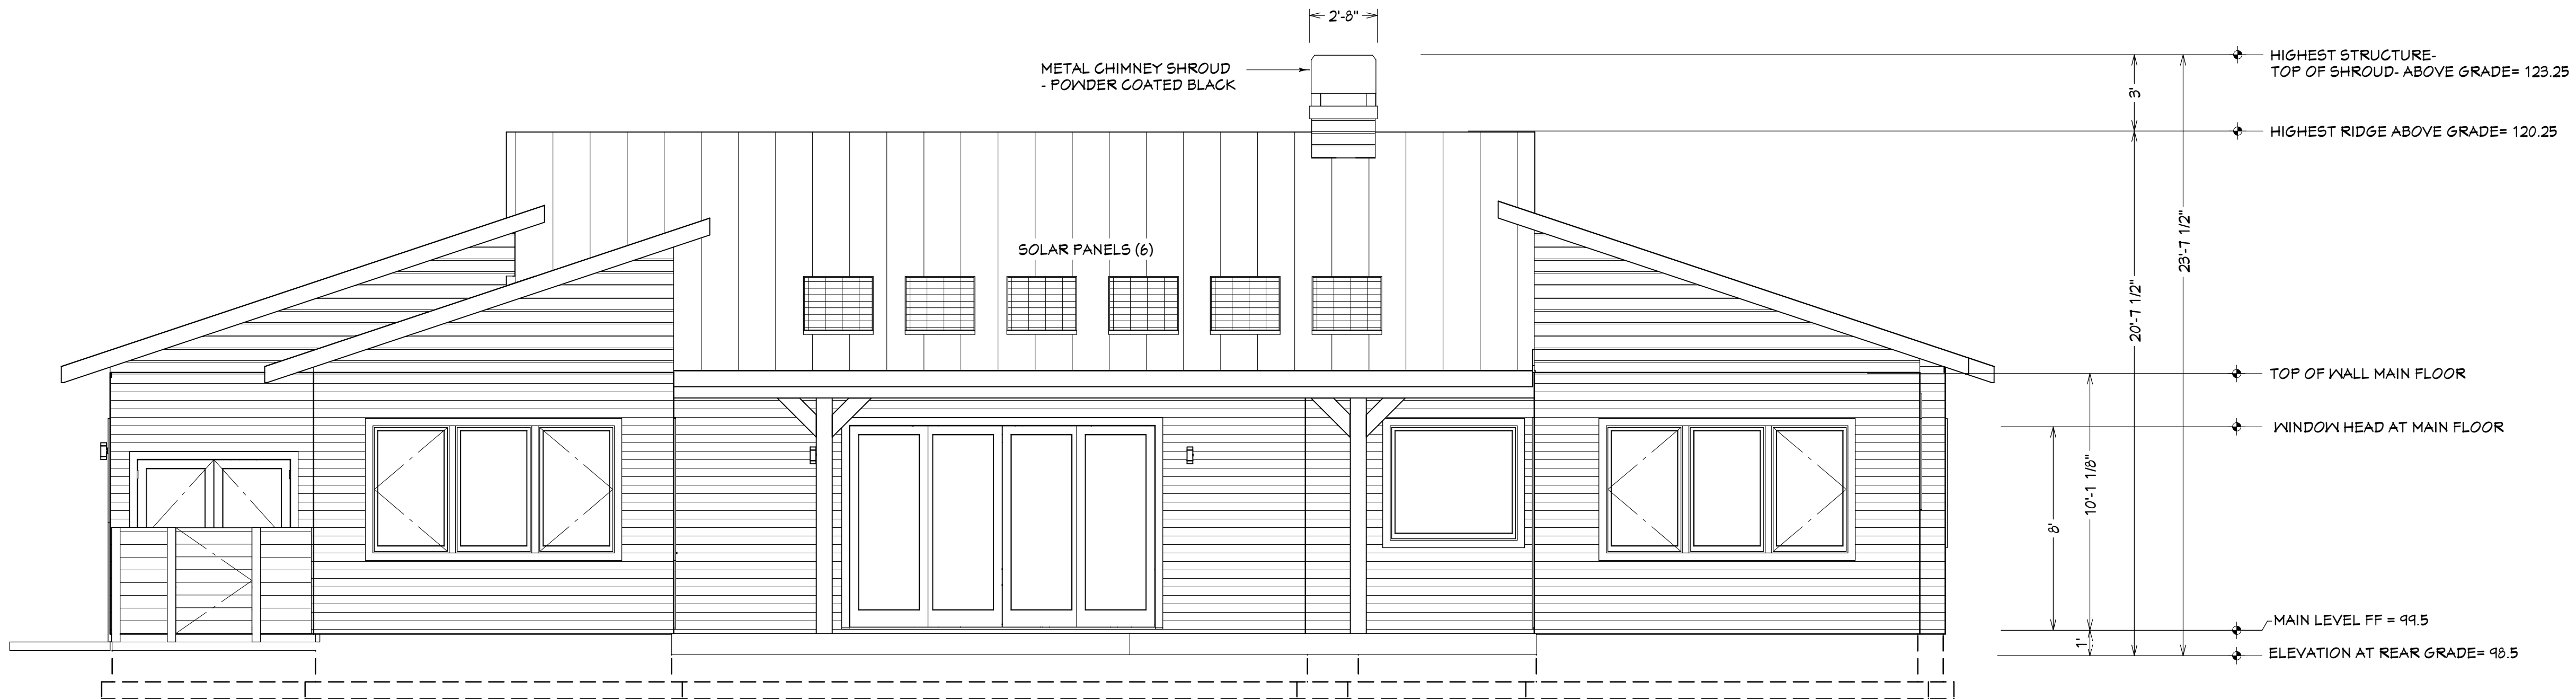

REAR ELEVATION

| REVISION TABLE | | DESCRIPTION | |
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LOT 13 RIVER MEADOWS
BEND OR, 97107

PROJECT FOR:
SIENNA BUILDING COMPANY
STEVE MCDONNELL
541-241-0406

RESIDENTIAL CONSTRUCTION
AND DESIGN

541-280-1120 PH FO BOX 1161
541-510-1744 FAX BEND OR, 97106
CGB# 165287

ROB RITTLETON INC.


DATE:
1/6/2017

SCALE:
1/4"=1' U.N.O.

SHEET TITLE:
EXTERIOR
ELEVATIONS

SHEET:
A2.01

RESERVED FOR BUILDING
DEPARTMENT STAMP

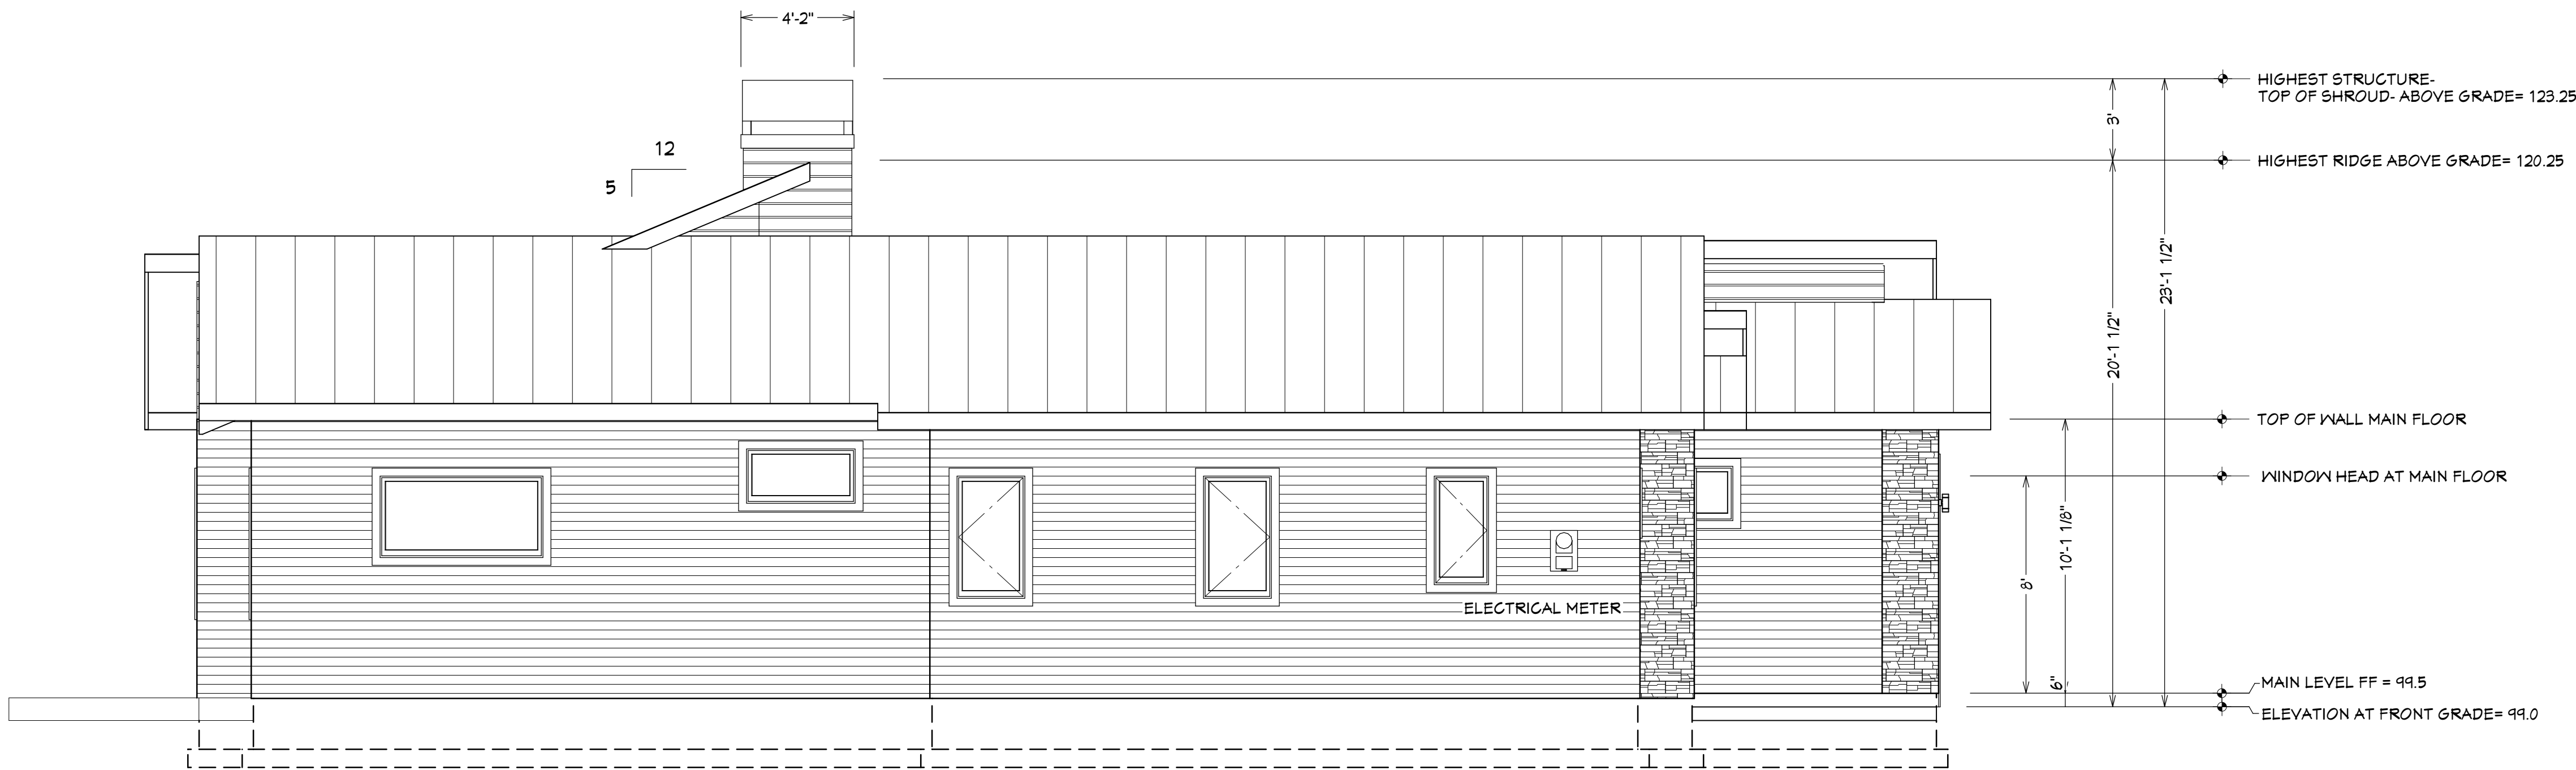


LEFT ELEVATION

EXTERIOR FINISH NOTES

- ROOFING - TAYLOR METALS - STANDING SEAM METAL, MEDIUM BRONZE
FASCIA - 2X8 PRIMED TRIM
- WINDOWS- ATRIUM - ADOBE
ENTRY DOOR- TO BE DETERMINED BY BUILDER
MASTER BEDROOM DOOR- THERMA-TRU FIBERGLASS, SINGLE PANEL GLASS
GARAGE AND STORAGE DOORS- THERMA-TRU SOLID PANEL, SW6075 GARRET GRAY
OVERHEAD GARAGE DOORS- WAYNE DALTON 8300- STEEL, SW6076- TURKISH COFFEE
- SIDING - MAIN BODY - 5 1/4" HARDI-LAP W/ 4" EXPOSURE, SW6075- GARRET GRAY
SIDING - GABLE ENDS & UPPER WALLS - 1X8 CVG CEDAR CHANNEL- HORIZONTAL
SIDING - DOG YARD
1X6 HORIZ. CEDAR SLAT SCREEN WALL
4X4 CEDAR POSTS
2X4 CEDAR CAP- CONT.
- CORNER TRIM - METAL CORNERS
- BAND TRIM - N/A
- WINDOW TRIM - 5/4 X 4 SIDE TRIM
5/4 X 4 APRON
5/4 X 4 HEAD
- STONE VENEER - ALPINE LEDGESTONE - PHEASANT
- EXPOSED BEAM MATERIAL- 8X12 RESAWN DF
EXPOSED POST AND KNEE BRACE SUPPORTS- 8X8 RESAWN DF
- CHIMNEY CHASE - 1X8 CEDAR CHANNEL - HORIZONTAL
CHIMNEY SHROUD - POWDER COATED METAL- DARK BRONZE
- SOLAR PANELS- TO BE DETERMINED BY BUILDER
TYP EXTERIOR WALL LIGHT- DESIGN LIGHTING CLASSICS- BRONZE CYLINDER WALL DOWN LIGHT

NOTE:
PROVIDE WINDOW FLASHING AND DRAIN-WRAP PER DETAILS.

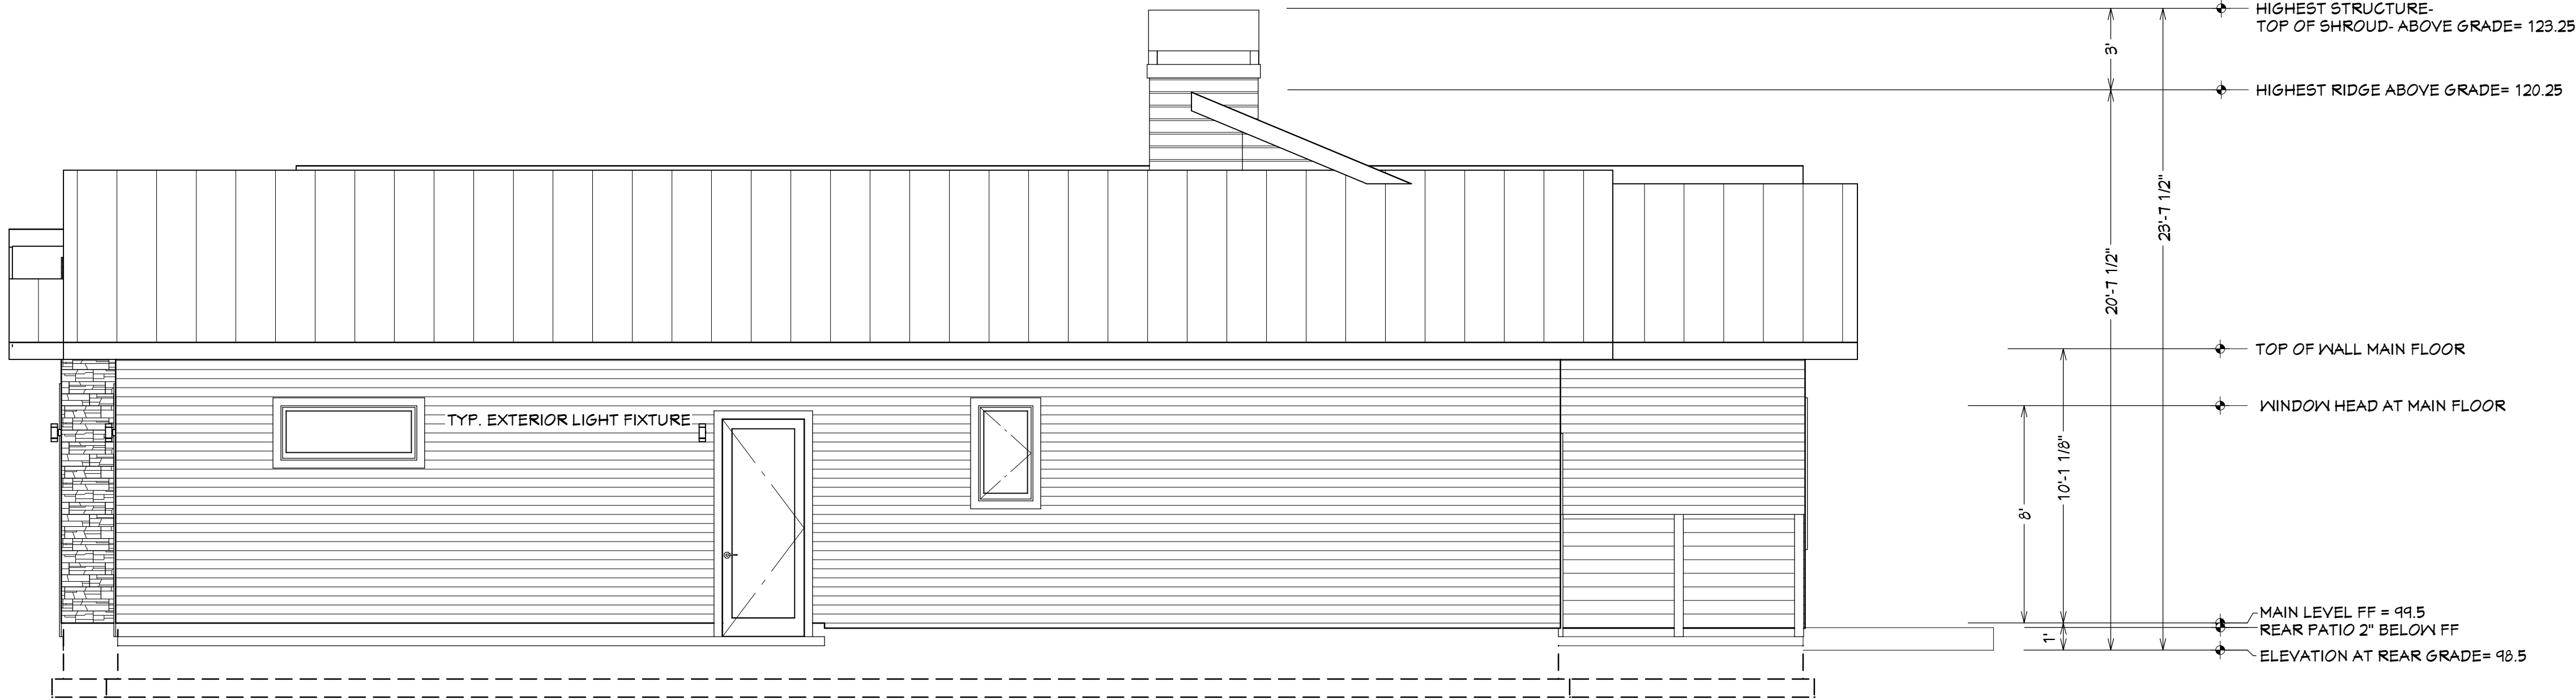

RIGHT ELEVATION

| REVISION TABLE | | DESCRIPTION | |
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| NUMBER | DATE | REV BY | DESCRIPTION |
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PROJECT LOCATION:
ROLIN RESIDENCE
LOT 13 RIVER MEADOWS
BEND OR, 97107

PROJECT FOR:
SIENNA BUILDING COMPANY
STIEVE MCDONNELL
541-241-0406

RESIDENTIAL CONSTRUCTION
AND DESIGN
541-280-1120 PH PO BOX 1167
541-610-1744 FAX BEND OR, 97106
CGB# 165287

ROBERT
PITTLTON INC.

DATE:

1/6/2017

SCALE:

1/4"=1' U.N.O.

SHEET TITLE:
EXTERIOR
ELEVATIONS

SHEET:

A2.02

| REVISION TABLE | | NUMBER | DATE | REV BY | DESCRIPTION |
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CCB# 165287

ROB
PITTLTON INC.

DATE:

1/6/2017

SCALE:

1/4"=1' U.N.O.

SHEET TITLE:
BUILDING
SECTIONS

SHEET:

A3.01

TYP ROOF ASSEMBLY:

- STANDING SEAM METAL ROOFING
- 15# MIN FELT PAPER
- CONTINUOUS RIDGE VENT OR CUT IN VENTS 1 SQFT PER 150 SQFT
- ICE AND WATER SHIELD TO COVER ALL ROOF AND EAVE AREAS UP PAST INTERIOR SIDE OF WALL
- MIN 5/8 OSB ROOF SHEATHING
- INSULATION PER CODE
- 2X12 GDF RAFTER OR MANF ROOF TRUSSES
- 1/2" GWB OR OTHER FINISH MATERIAL

SIDING AT UPPER WALLS AND RAKES-
1X8 CVG CEDAR CHANNEL- HORIZONTAL


TYP WALL ASSEMBLY:

- FINISH SIDING MATERIAL 4" EXPOSURE
- HARDI-PLANK LAP
- AIR INFILTRATION BARRIER
- 1/16" OSB WALL SHEATHING
- 2X6 GDF STUDS @ 16" O/C
- MIN R21 INSULATION
- 1/2" GWB


TYP FLOOR ASSEMBLY:

- FINISH FLOOR MATERIAL
- 1/8" EDGEGLD FLOOR SHEATHING
- FLOOR JOISTS PER FRAMING PLAN
- BATT INSULATION PER CODE
- POURED CONCRETE WALL AND FOOTING PER FOUNDATION NOTES
- PROVIDE 6MIL VAPOR BARRIER AT CRAWL SPACE

PRELIMINARY SECTION - A

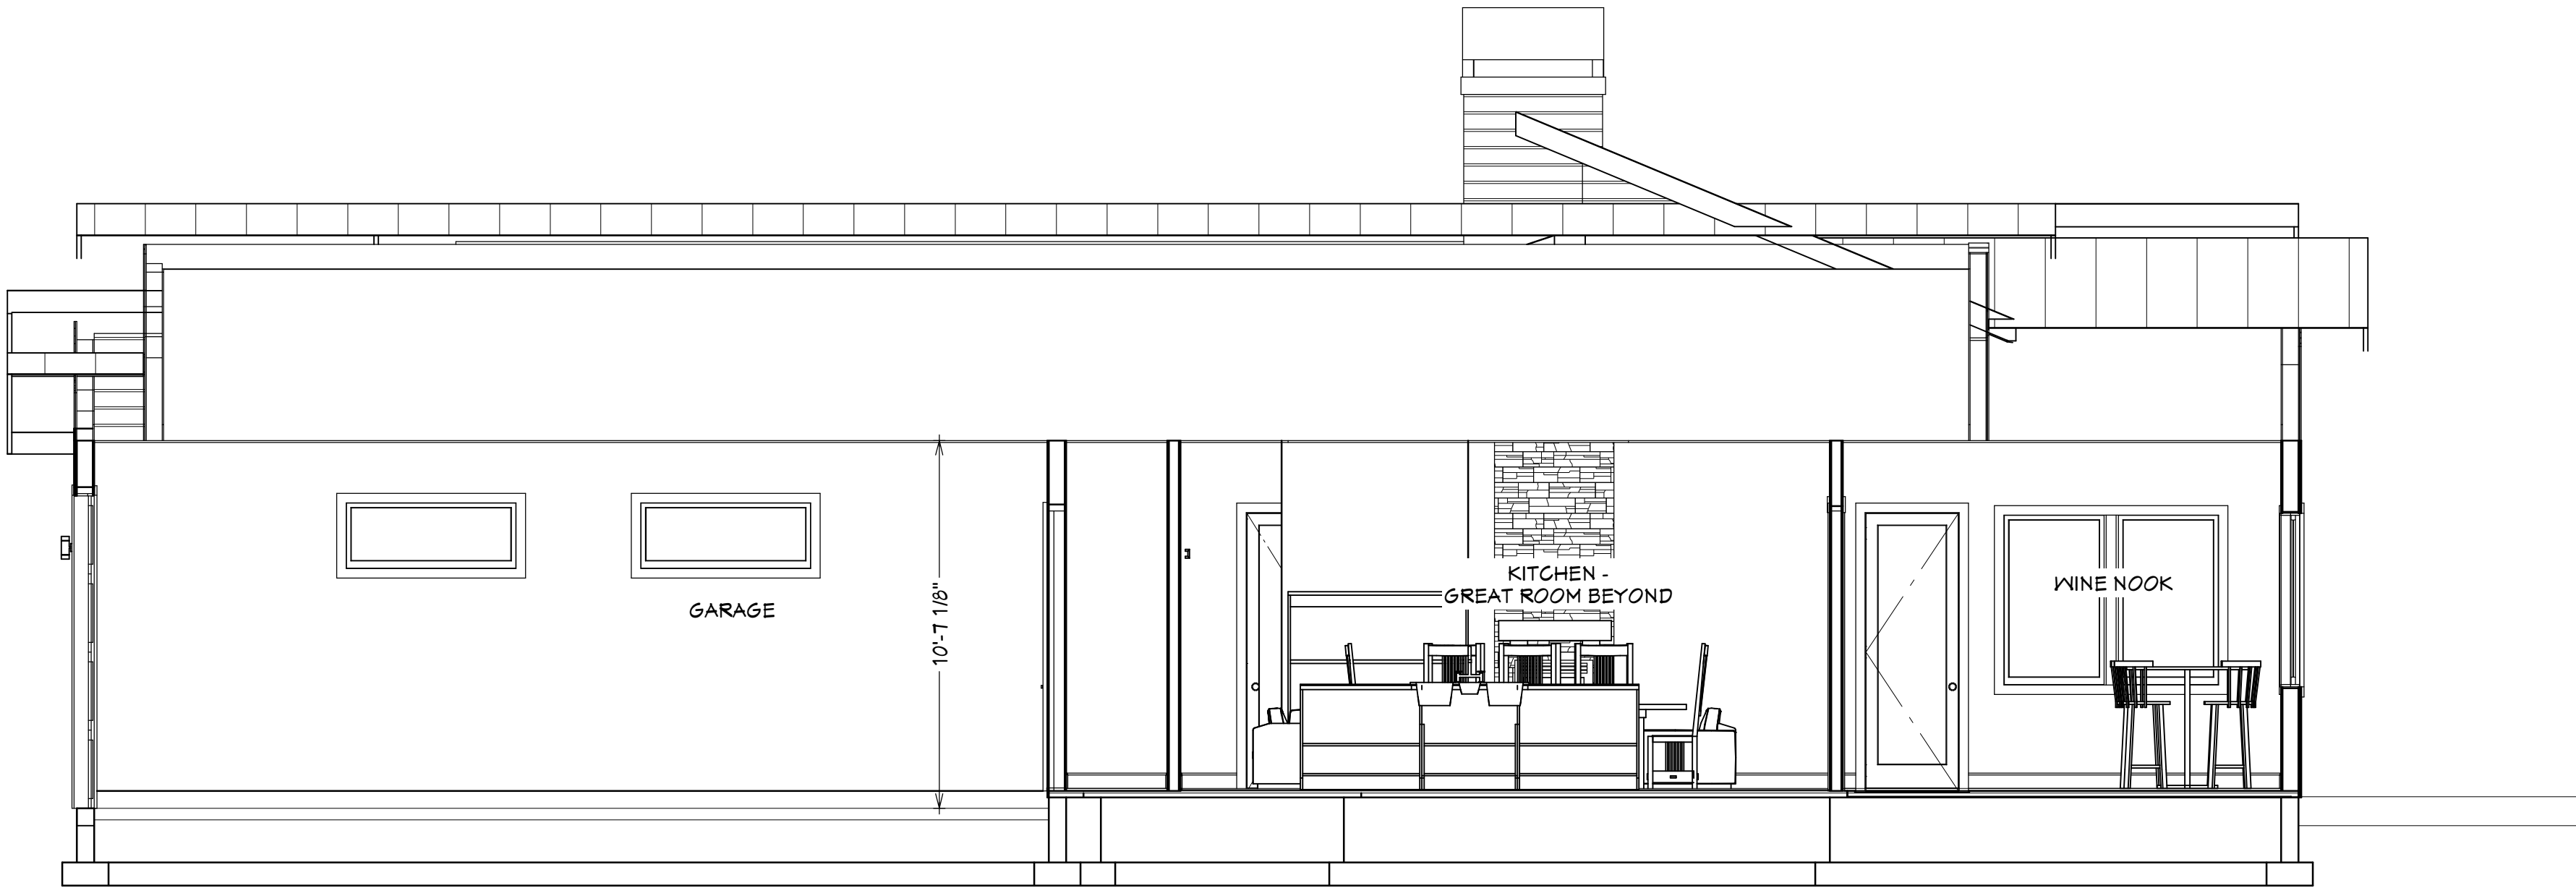

PRELIMINARY SECTION - B

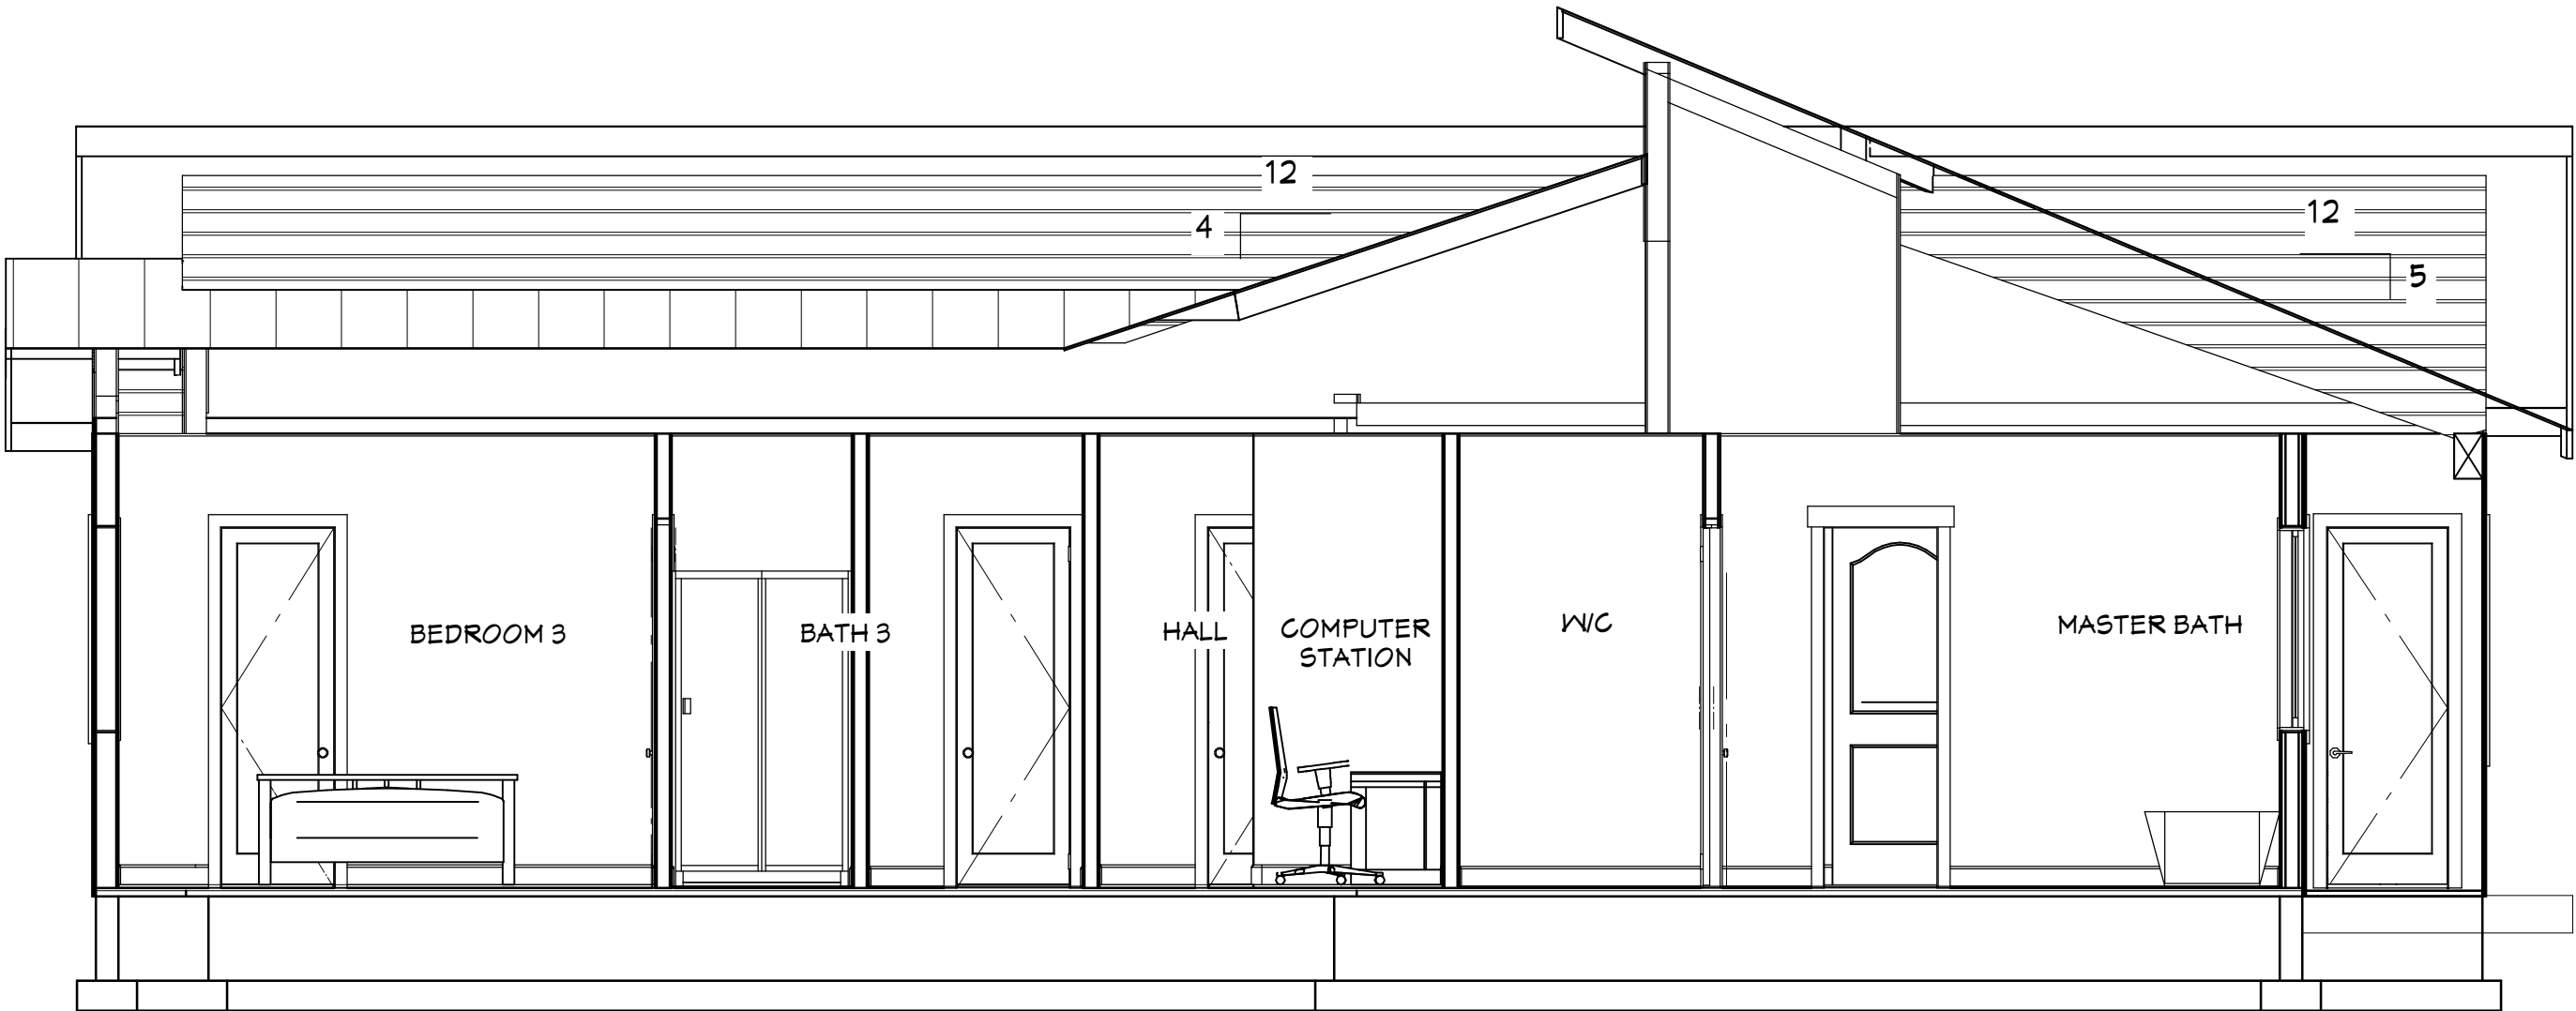

PRELIMINARY SECTION - C

RESERVED FOR BUILDING
DEPARTMENT STAMP

| REVISION TABLE | |
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BEND OR, 97107

PROJECT FOR:
SIENNA BUILDING COMPANY
STEVE McDOWELL
541-241-0406

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AND DESIGN
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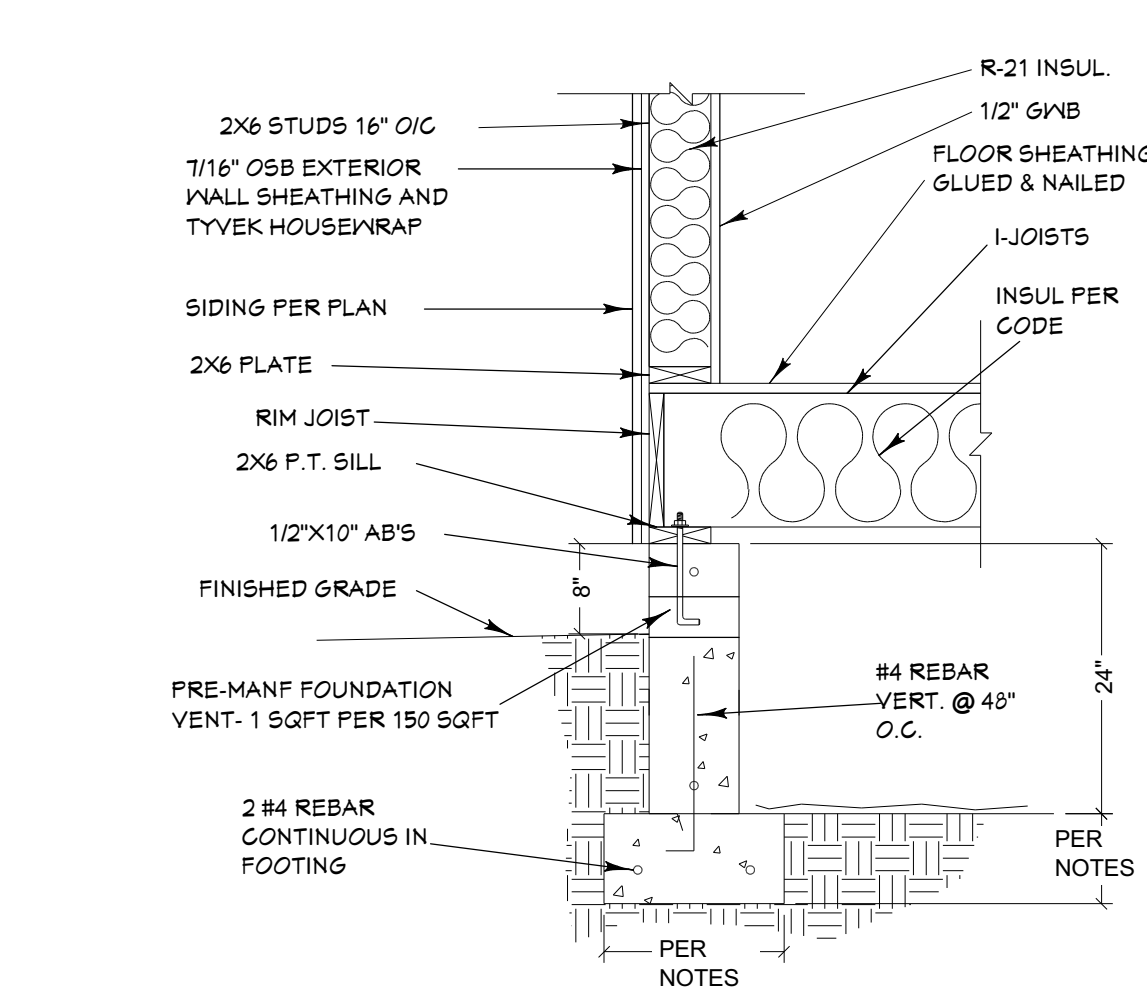
SCALE:

1/4"=1' U.N.O.


SHEET TITLE:
DETAILS:
STRUCTURAL

SHEET:


S5.01




FD1
S5.01
TYP. FOUNDATION STEMWALL AND FOOTING
3/4" = 1'

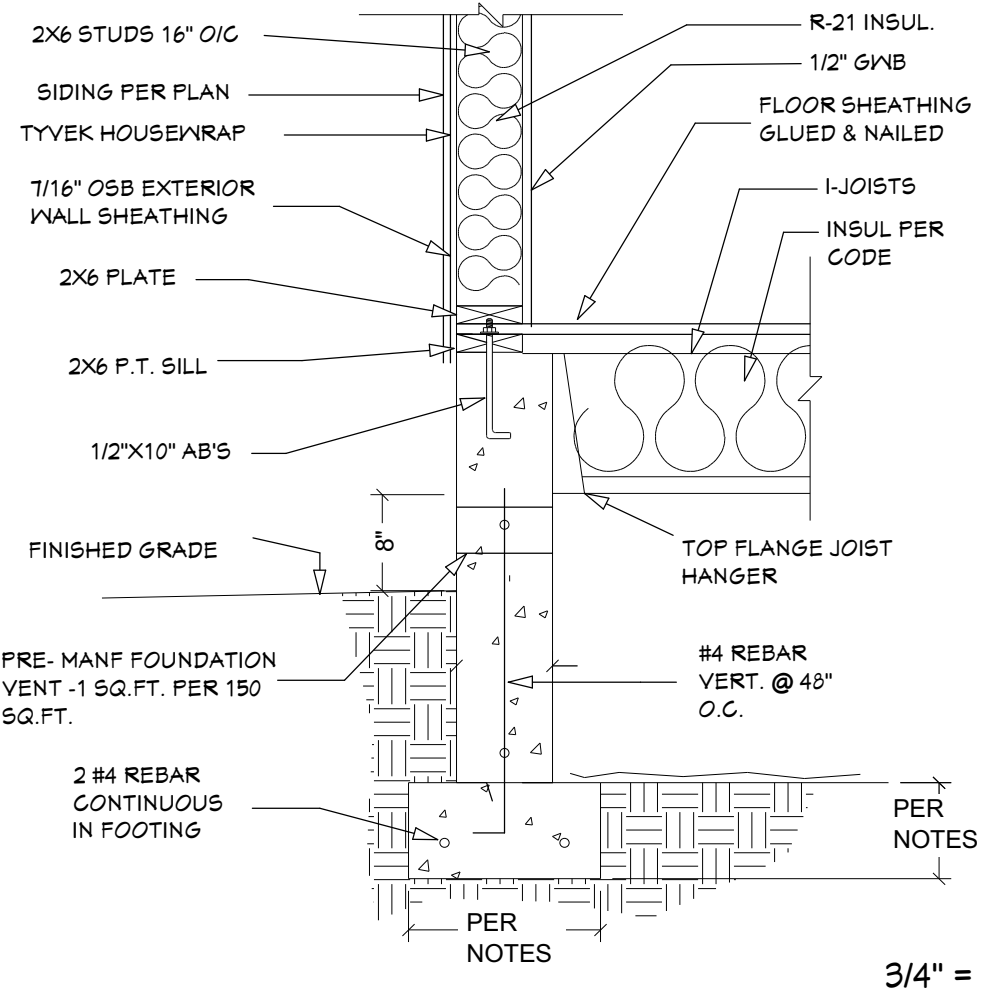

FD2
S5.01
TYP. FOUNDATION STEMWALL AND FOOTING W/ HUNG FLOOR
3/4" = 1'

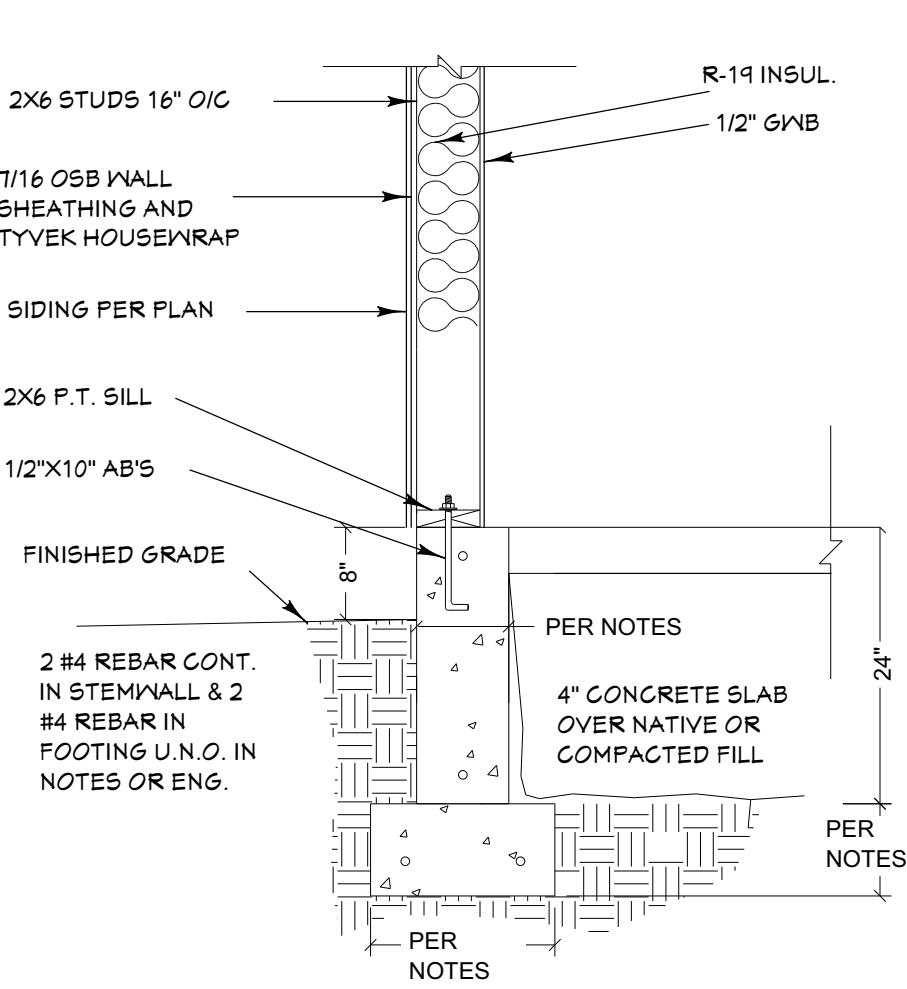


FD3
S5.01
TYP. FOUNDATION STEMWALL AND FOOTING AT SLAB
3/4" = 1'

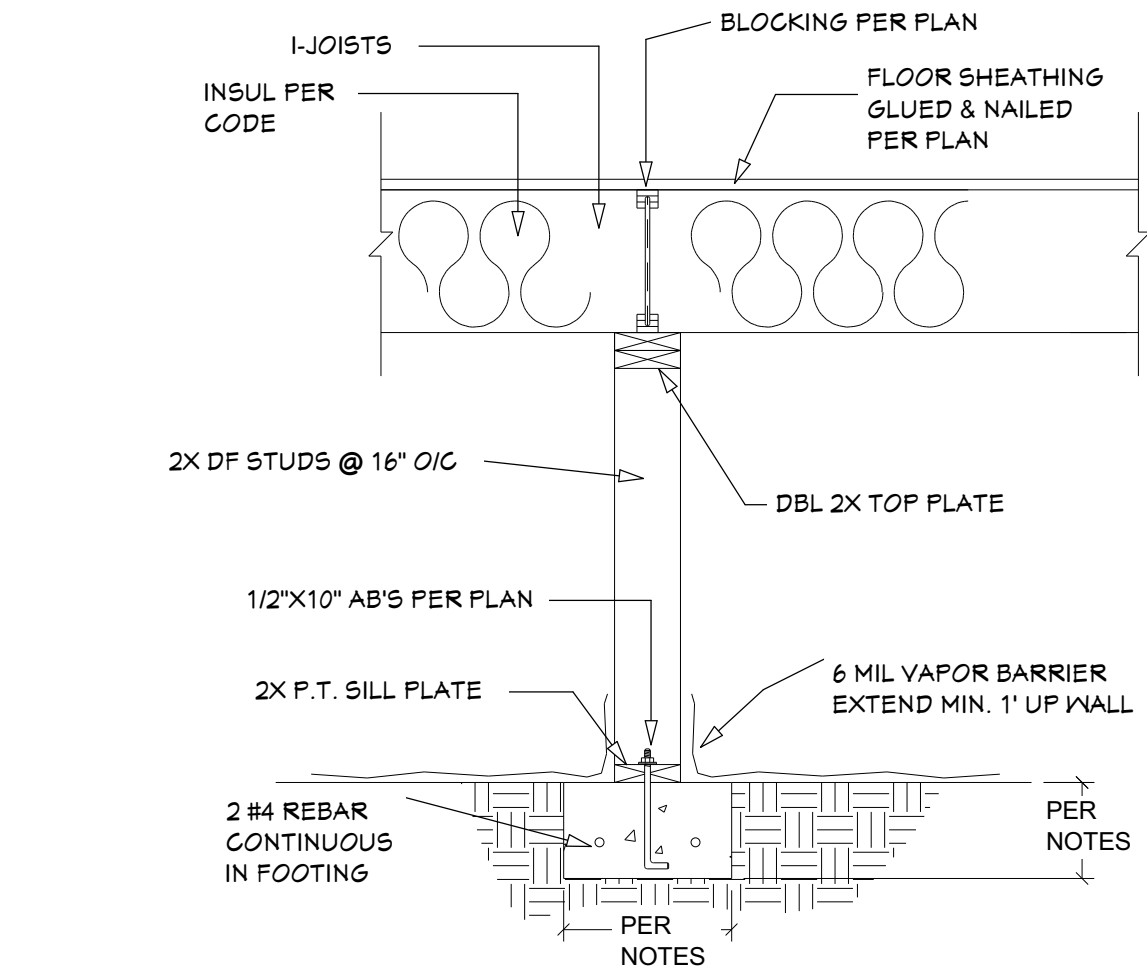


FD4
S5.01
TYP. INTERIOR FRAMED WALL AND FOOTING AT CRAWLSPACE
3/4" = 1'


NOT USED

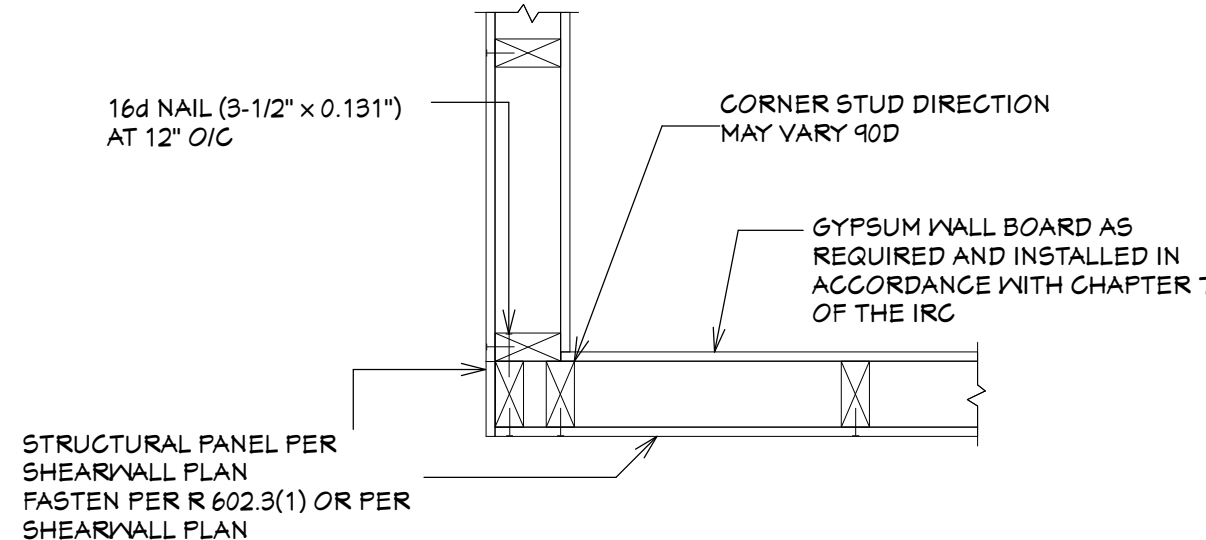

WD1
S5.01
FRAMED WALL DETAIL- OUTSIDE CORNER
3/4" = 1'

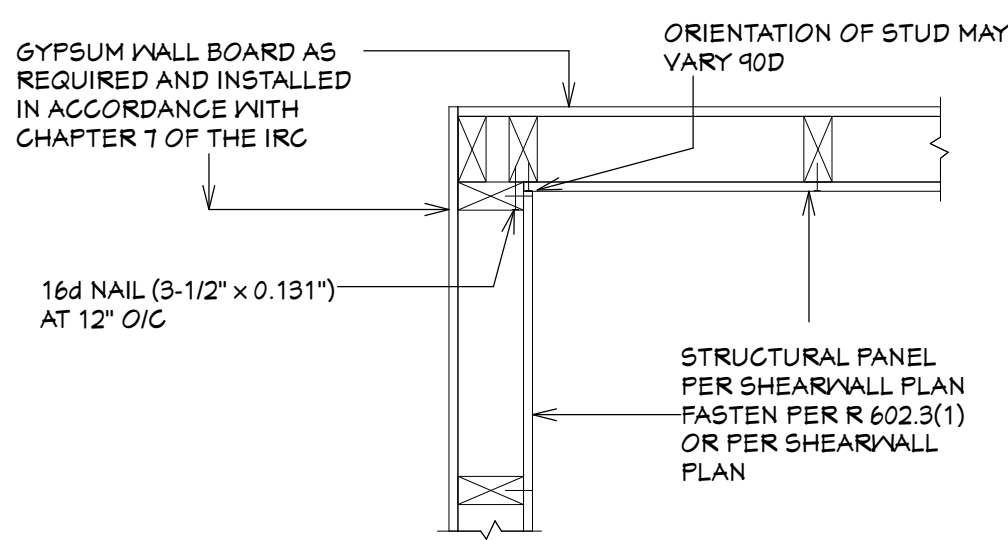


WD2
S5.01
FRAMED WALL DETAIL- INSIDE CORNER
3/4" = 1'

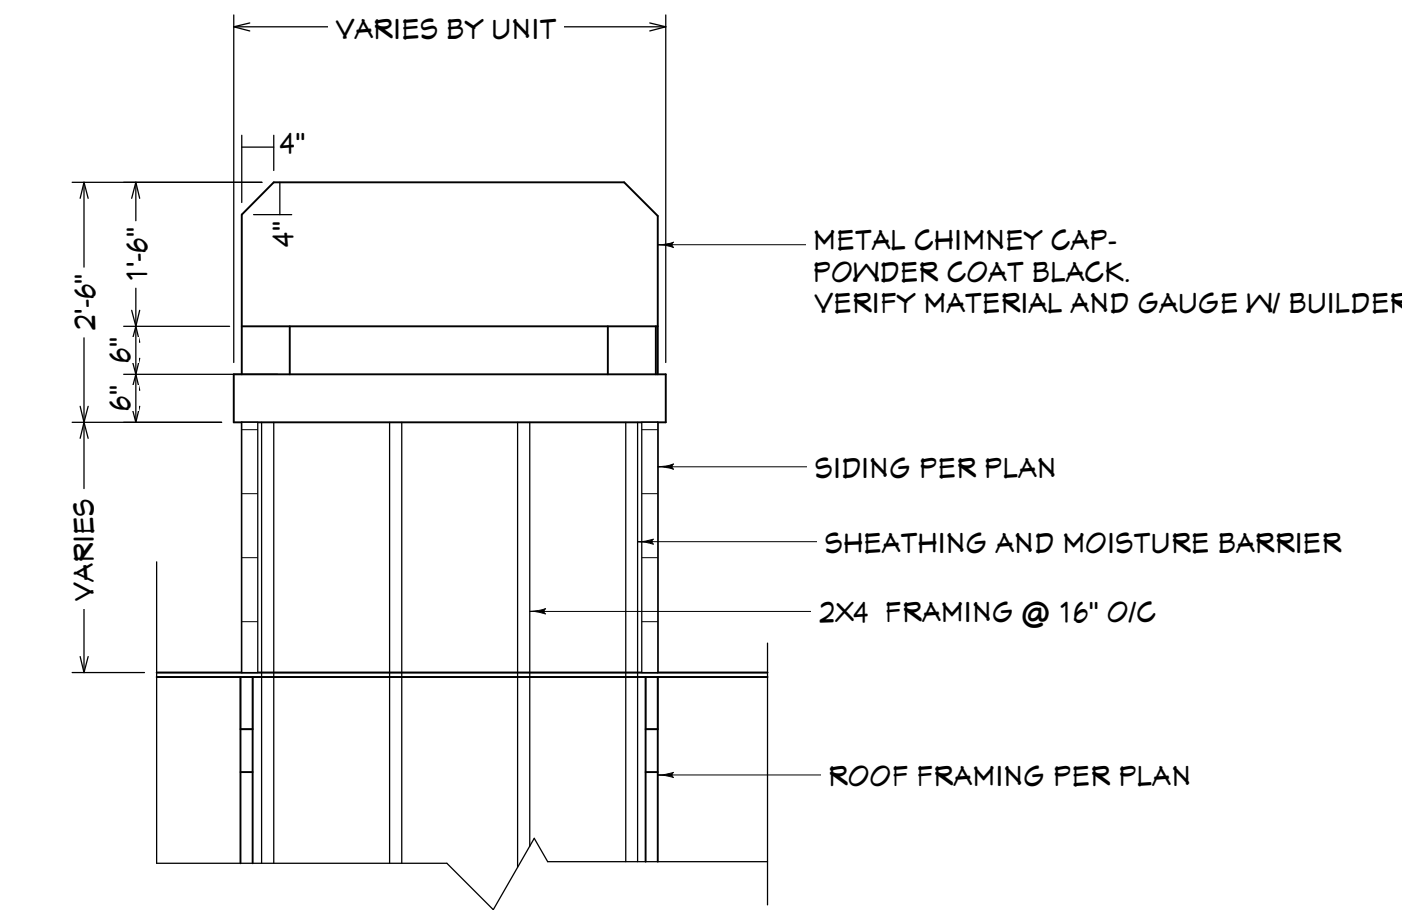


CC1
A5.01
CHIMNEY CHASE AND CAP
1/2" = 1'

NOT USED

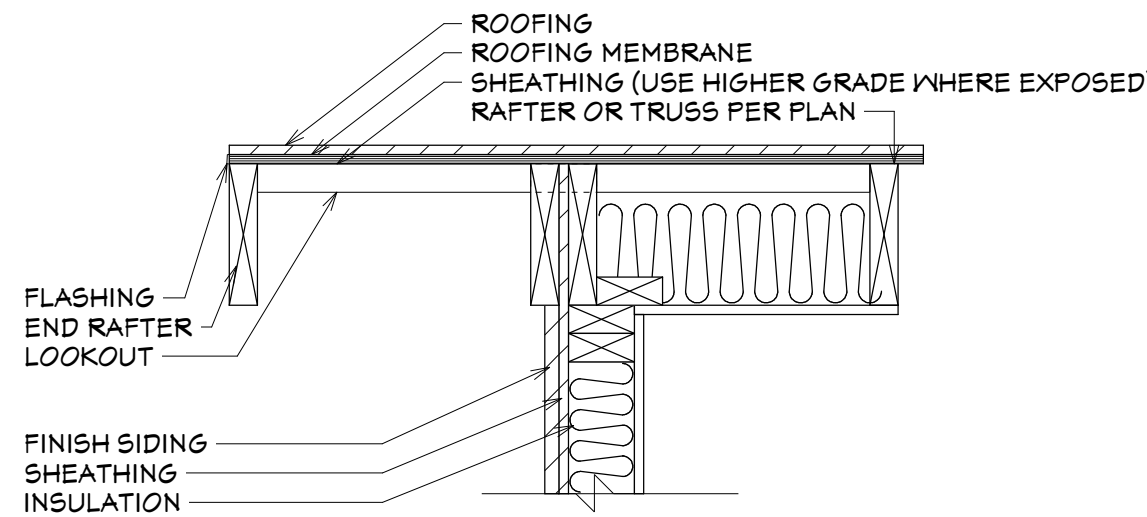

RR1
S5.01
ROOF OVERHANG AT RAKE
3/4" = 1'

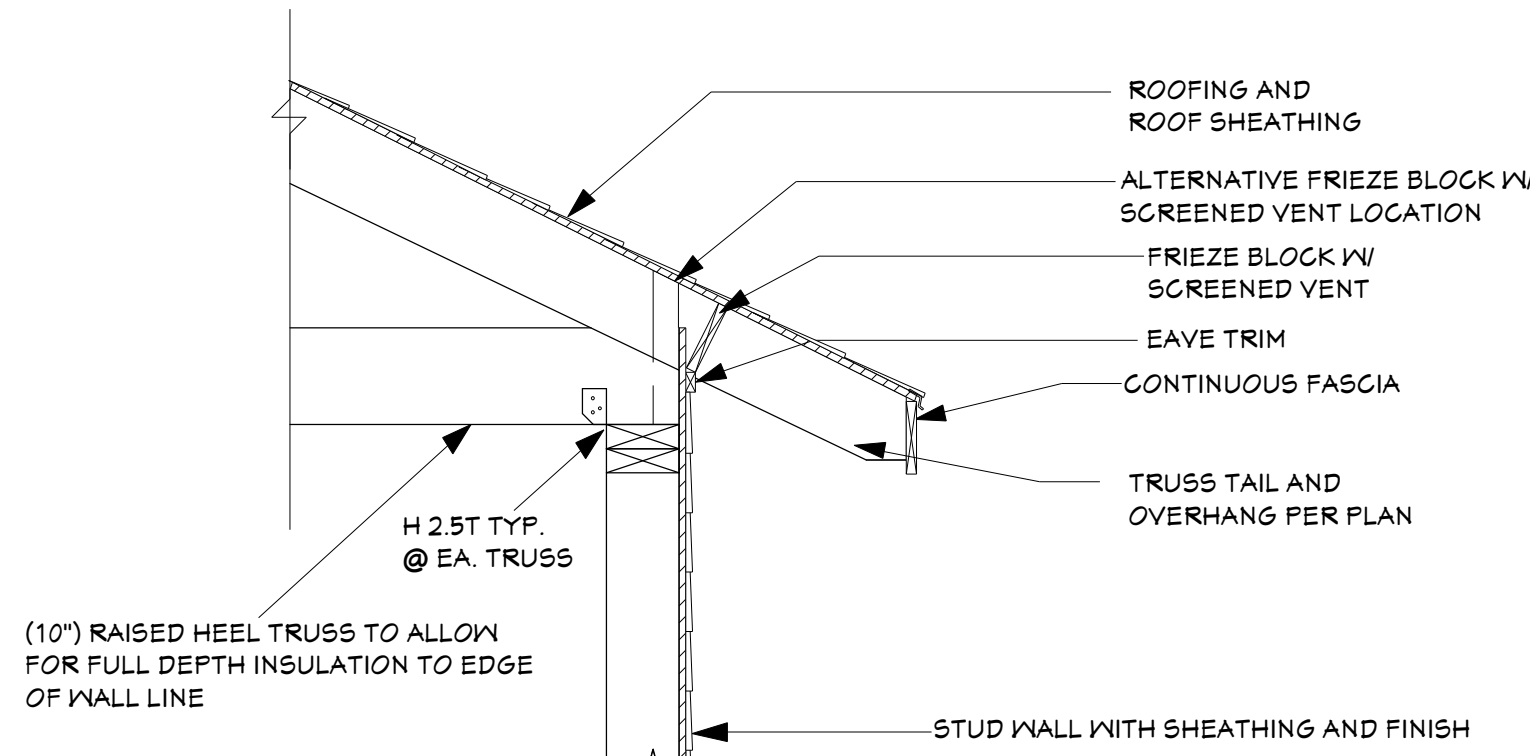

RE1
S5.01
ROOF OVERHANG AT EAVE
3/4" = 1'