DESIGN LOADS:

SNOW - 25 LBS. + DRIFT

MIND - 100 MPH

SEISMIC DESIGN CATEGORY C

FROST DEPTH - 18 INCHES

EXPOSURE - B OR C DEPENDING ON AREA

MINIMUM UNIFORM LIVE LOADS

BALCONIES - 60 LBS. SQ.FT.

DECKS - 40 LBS. SQ.FT.

FIRE ESCAPES - 40 LBS. SQ.FT.

GARAGES - 50 LBS. SQ.FT.

ATTICS (NO STORAGE) - 10 LBS. SQ.FT.
ATTICS (LIMITED STORAGE) - 20 LBS. SQ.FT.
ATTICS (SERVED W/ FIXED STAIRS) - 30 LBS. SQ.FT.

DWELLINGS - 40 LBS. SQ.FT.

STAIRS - 40 LBS. SQ.FT.

GUARDRAILS & HANDRAILS 200 LBS. SQ.FT.

ADDITIONAL ENERGY MEASURES PROVIDED.

RESIDENTIAL ENERGY ENVELOPE ENHANCEMENT MEASURE 3: INSULATION:

FLOORS-UNDERFLOOR- R30 SLAB EDGE PERIMETER- R15 HEATED SLAB, INTERIOR- R10

FLOOR ASSEMBLY OVER UNCONDITIONED SPACE- R30 WALLS-

ABOVE GRADE- R21 BELOW GRADE- R19 F

BELOW GRADE- R19 FOR FRAMED ASSEMBLIES OR R15 CONTINUOUS CEILINGS-

FLAT- R49 WITH MIN R21 AT EDGE SCISSOR TRUSS VAULT- R38 RAFTER VAULT- R30

WINDOWS- U0.30, AND PERFORMANCE TESTED DUCT SYSTEM

CONSERVATION MEASURE OPTION A- HIGH EFFICIENCY HVAC SYSTEM GAS FIRED FURNACE OR BOILER WITH MINIMUM AFUE OF 90% OR AIR-SOURCE HEAT PUMP WITH MINIMUM HSPF OF 8.5

OR CLOSED LOOP GROUND SOURCE HEAT PUMP WITH MINIMUM COP OR 3.0

GLAZING NOTE: ALL GLAZING SHALL CONFORM TO ADDITIONAL ENERGY MEASURES SPECIFIED IN

ATTACHED ENERGY CHECKLIST

INSULATION NOTE:
ALL INSULATION SHALL CONFORM TO ADDITIONAL ENERGY MEASURES SPECIFIED IN
ATTACHED ENERGY CHECKLIST

PROJECT INFO

BUILDER: SIENNA BUILDING 541-241-0406

DESIGNER: ROB LITTLETON INC. 541-280-1120

ENGINEER: ECLIPSE ENGINEERING 541-389-9659

BLDG PERMIT#:

BUILDING AREA:

 FLOOR 1:
 2192 SQ. FT.

 FLOOR 2:
 958 SQ. FT.

 TOTAL LIVING:
 3150 SQ. FT.

 GARAGE:
 865 SQ. FT

ROB LITTLETON INC. DOES NOT REPRESENT ITSELF AS AN ARCHITECT, ENGINEER OR SURVEYOR. IT IS THE SOLE RESPONSIBILITY OF THE OWNER/BUILDER TO OBTAIN ALL BUILDING PERMITS AND TO VERIFY ALL DIMENSIONS, CONSTRUCTION METHODS AND SITE CONDITIONS WITH THEIR CONTRACTOR, ENGINEER AND/ OR SURVEYOR PRIOR TO CONSTRUCTION.





		LAYOUT PAGE TABLE
NUMBER	LABEL	TITLE
1	A0.01	COVER SHEET
2	A0.02	PLAN NOTES
3	A1.01	SITE PLAN
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5	A1.03	UPPER FLOOR PLAN & SECTION
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10	A2.02	EXTERIOR ELEVATIONS

RESERVED FOR BUILDING DEPARTMENT STAMP

REVISION TABLE
IBER DATE REV BY DESCRIF
4/16/2015 ROB LITTLETON ARC PRI

PROJECT LOCATION: LOT 119 AWBREY PARK, PHASE 3

> SIENNA BUILDING 541-241-0406

RESIDENTIAL CONSTRUCTION AND DESIGN 541-280-1120 PH PO BOX 716-541-610-1744 FAX BEND OR,917(

DATE: 4/16/2015

SCALE: 1/4"=1' U.N.O.

SHEET TITLE:

COVER PAGE

SHEET: A0.01 OBTAIN ALL PERMITS AND APPROVALS.

GOVERN. NOTIFY THE DESIGNER OF ALL CONFLICTS.

COMPLIANCE WITH THE DRAWINGS AND SPECIFICATIONS.

1. THE CONTRACTOR SHALL BE RESPONSIBLE FOR SAFETY IN THE AREA OF WORK IN ACCORDANCE WITH ALL APPLICABLE SAFETY CODES.

CAUSED BY NEGLIGENCE OF THE CONTRACTOR, HIS AGENTS, EMPLOYEES OR SUBCONTRACTORS.

DISCREPANCIES OR CONDITION ADVERSELY AFFECTING THE DESIGN PRIOR TO PROCEEDING WITH THE WORK.

3. INTERIOR DIMENSIONS OF PLANS ARE TO GRIDLINES OR FACE OF FRAMING UNLESS NOTED OTHERWISE.

1. PROVIDE FIRE PROTECTION AT ALL PENETRATIONS OF FIRE RATED ELEMENTS AS REQUIRED BY THE CODE

2. CONTRACTOR SHALL BE RESPONSIBLE FOR PROVIDING WALL BLOCKING FOR ALL WALL AND CEILING MOUNTED ITEMS.

<u>USE</u> (SIMPLE SPAN)

(CONT. OR CANTILEYER)

2. EXTERIOR DIMENSIONS OF PLANS ARE TO BUILDING GRIDLINES OR FACE OF FRAMING UNLESS NOTED OTHERWISE.

2. THE CONTRACTOR SHALL INDEMNIFY AND HOLD THE DESIGNER/ENGINEER HARMLESS FOR INJURY OR DEATH TO PERSONS OR FOR DAMAGE TO PROPERTY

3. EACH CONTRACTOR SHALL BE RESPONSIBLE FOR DAMAGE TO ADJACENT WORK AND SHALL REPAIR SAID DAMAGE AT HIS OWN EXPENSE. CONTRACTOR TO

4.CODES: ALL WORK SHALL CONFORM TO THE APPLICABLE BUILDING CODES AND ORDINANCES. IN CASE OF CONFLICT WHERE METHODS OR STANDARDS OF INSTALLATION OF THE MATERIALS SPECIFIED DO NOT EQUAL OR EXCEED THE REQUIREMENTS OF THE LAWS OR ORDINANCES, THE LAWS OR ORDINANCES SHALL

1.ALL INFORMATION SHOWN ON THE DRAWINGS, RELATIVE TO THE EXISTING CONDITIONS ARE GIVEN AS THE BEST PRESENT KNOWLEDGE BUT WITHOUT GUARANTEE OF ACCURACY, THE CONTRACTOR SHALL FIELD VERIFY EXISTING CONDITIONS AND DIMENSIONS AND SHALL NOTIFY THE DESIGNER OF ANY

5. COORDINATION: THE CONTRACTOR SHALL BE RESPONSIBLE FOR THE VERIFICATION AND COORDINATION OF THE WORK OF ALL TRADES TO ASSURE

4. DO NOT SCALE DRAWINGS: THE CONTRACTOR SHALL USE DIMENSIONS SHOWN ON THE PLANS AND ACTUAL FIELD MEASUREMENTS. NOTIFY THE DESIGNER IF

1. CONTRACTOR SHALL INVESTIGATE AND VERIFY LOCATIONS OF STRUCTURAL, MECHANICAL AND ELECTRICAL ELEMENTS AND OTHER EXISTING CONDITIONS

3. THERE SHALL BE NO EXPOSED PIPES, CONDUITS, DUCTS, VENTS, ETC. ALL SUCH LINES SHALL BE CONCEALED OR FURRED AND FINISHED, UNLESS NOTED AS

5. GENERAL CONTRACTOR IS TO COORDINATE WITH ELECTRICAL AND PLUMBING CONTRACTORS FOR ALL REQUIRED ROUGH-INS AND TRENCHING REQUIRED

SAWN LUMBER DESIGN IS BASED ON THE NATIONAL DESIGN SPECIFICATION, LATEST EDITION. SAWN LUMBER SHALL CONFORM TO WEST COAST LUMBER INSPECTION BUREAU OR

STRONG-TIE COMPANY (OR ENGINEER APPROVED EQUAL) AND OF THE SIZE AND TYPE SHOWN ON THE DRAWINGS. HANGERS NOT SHOWN SHALL BE SIMPSON HU OF SIZE

CMU SHALL BE PRESSURE TREATED UNLESS AN APPROVED BARRIER IS PROVIDED. FRAMING ACCESSORIES AND STRUCTURAL FASTENERS SHALL BE MANUFACTURED BY SIMPSON

PLYWOOD PANELS SHALL CONFORM TO THE REQUIREMENTS OF "U.S. PRODUCT STANDARD PS 1 FOR CONSTRUCTION AND INDUSTRIAL PLYWOOD" OR APA PRP-108 PERFORMANCE

BE IN CONFORMANCE WITH APA RECOMMENDATIONS. ALLOW 1/8" SPACING AT PANELS ENDS AND EDGES, UNLESS OTHERWISE RECOMMENDED BY THE PANEL MANUFACTURER.

SHALL BE BLOCKED WITH 2X FRAMING AT ALL PANEL EDGES. NAILING NOT SPECIFICALLY IDENTIFIED ON THE DRAWINGS TO CONFORM WITH IRC TABLE R602.3(1).

RECOMMENDED FOR MEMBER. ALL HANGERS AND NAILS IN CONTACT WITH PRESSURE TREATED LUMBER SHALL BE SIMPSON Z-MAX HANGERS OR STAINLESS STEEL. ALL SHEAR WALL

SHEATHING NAILS SHALL BE COMMON NAILS ALL FRAMING NAILS SHALL BE COMMON NAILS. OR HOT DIPPED GALVANIZED BOX NAILS. FRAMING NAILS SHALL BE PER IBC TABLE 2304.9.1

STANDARDS. UNLESS NOTED, PANELS SHALL BE APA RATED SHEATHING, EXPOSURE 1, OF THE THICKNESS AND SPAN RATING SHOWN ON THE DRAWINGS. PLYWOOD INSTALLATION SHALL

ALL ROOF SHEATHING AND SUB-FLOORING SHALL BE INSTALLED WITH FACE GRAIN PERPENDICULAR TO SUPPORTS, EXCEPT AS INDICATED ON THE DRAWINGS. SHEAR WALL SHEATHING

GLUED LAMINATED MEMBERS SHALL BE FABRICATED IN CONFORMANCE WITH U.S. PRODUCT STANDARD PS 56, "STRUCTURAL GLUED LAMINATED TIMBER" AND AMERICAN INSTITUTE OF TIMBER CONSTRUCTION, AITC 117. EACH MEMBER SHALL BEAR AN AITC OR APA-EWS IDENTIFICATION MARK AND BE ACCOMPANIED BY A CERTIFICATE OF CONFORMANCE. ONE COAT OF

END SEALER SHALL BE APPLIED IMMEDIATELY AFTER TRIMMING IN EITHER SHOP OR FIELD. GLULAM HANGERS NOT SHOWN SHALL BE SIMPSON EG. BEAMS SHALL BE VISUALLY GRADED

PREMANUFACTURED WOOD JOISTS: PREMANUFACTURED WOOD JOISTS SHALL BE OF THE SIZE AND TYPE SHOWN ON THE DRAWINGS, MANUFACTURED BY THE TRUS JOIST COMPANY, OR

ROOF FRAMING NOTES

@ 24" O.C. (U.N.O)

@ 48" O.C. MAX.)

TYP. ROOF FRAMING WILL BE MANUFACTURED TRUSSES @ 24" O.C. OR #2 D.F. RAFTERS

TRUSS MANUFACTURER TO PROVIDE ALL DRAWINGS AND ENGINEERING FOR TRUSSES.

OVERFRAME IN DESIGNATED AREAS IV/ 2X6 #2 D.F. (SUPPORT TO MAIN ROOF FRAMING

TYP HEADER TO BE 4X8 GDF UNO ON HEADER SCHEDULE.

30# ROOFING FELT & STANDING SEAM METAL ROOFING.

PROVIDE ROOF VENTING PER CODE

TRUSS MANUFACTURER TO SPECIFY ALL CONNECTIONS AND HANGERS.

SHEATHING TO BE 7/16" OSB OR EQ. NAILED @ 6" EDGES & 12" FIELD.

PROVIDE 2 COURSES OF ICE DAM PROTECTION MIN AT ROOF PERIMETER

INSTALL ALL PERMANENT BRACING AS PER ENGINEERED TRUSSES DRAWINGS.

AN ENGINEER APPROVED EQUAL. PROVIDE BRIDGING IN CONFORMANCE WITH THE MANUFACTURERS RECOMMENDATIONS. JOISTS AND BRIDGING SHALL BE CAPABLE OF RESISTING

THE WIND UPLIFT NOTED ON THE DRAWINGS. THE JOIST MANUFACTURER SHALL VISIT JOB SITE AS REQUIRED AND VERIFY THE PROPER INSTALLATION OF JOISTS IN WRITING TO THE

ARCHITECT/ENGINEER. PREMANUFACTURED WOOD JOIST ALTERNATES WILL BE CONSIDERED, PROVIDED THE ALTERNATE IS COMPATIBLE WITH THE LOAD CAPACITY, STIFFNESS,

WESTERN WOOD PRODUCTS ASSOCIATION GRADING RULES. ALL LUMBER NOT SPECIFICALLY NOTED TO BE D.F. #2 OR BETTER. ALL WOOD IN PERMANENT CONTACT WITH CONCRETE OR

6. PROVIDE PRESSURE TREATED WOOD AT ALL LOCATIONS WHERE WOOD IS TO BE EXPOSED TO THE EXTERIOR OR WHERE WOOD COMES INTO CONTACT

DIMENSIONS:

DISCREPANCIES ARE FOUND.

PRIOR TO BEGINNING THE WORK.

WITH CONCRETE OR SOIL.

OR IRC TABLE R602.3(1).

COMBINATION

SYMBOL 24F - V4

24F - V8

LUMBER SPECIES:

EXPOSED ON THE CONSTRUCTION DRAWINGS.

FOR ELECTRICAL AND PLUMBING RUNS.

4. PROVIDE GALVANIC ISOLATION BETWEEN DISSIMILAR METALS.

WESTERN SPECIES INDUSTRIAL GRADE, AND OF THE STRENGTH INDICATED BELOW:

DIMENSIONAL, AND FIRE RATING REQUIREMENTS OF THE PROJECT, AND IS ICBO APPROVED.

SPECIES DF/DF

ROOF SHEATHING SHALL BE 1/2" CDX INT-APA RATED 32/16 OR 7/16" OSB.

WALL SHEATHING SHALL BE 1/2" INT-APA RATED 32/16 OR 7/16" OSB.

G. ALL WOOD IN CONTACT WITH CONCRETE SHALL BE PRESSURE TREATED.

TOE NAIL (3)-8d

END NAIL (2)-16d

FACE NAIL (2)-16d

TOE NAIL (3)-8d

TOE NAIL (4)-8d

FACE NAIL (3)-10d

TOE NAIL (2)-16d

EDGES 8d @ 6" OC

EDGES 8d @ 6" OC

INTERMEDIATE 8d @ 12" OC

10d **@** 24" *OC*

FACE NAIL 16d @ 16"OC

FACE NAIL 16d @ 24" OC

FACE NAIL 16d @ 16" OC

TOE NAIL (4)-8d, END NAIL (2) 16d

16d @ 16" OC ALONG EA. EDGE

INTERMEDIATE 8d @ 12" OC (U.N.O. IN ENG.)

FLOOR SHEATHING SHALL BE 3/4" T & G INT-APA RATED OSB.

F. 'I'JOISTS SHALL BE MANUFACTURED BY TRUS JOIST OR

DF/DF

A. POSTS, BEAMS, HEADERS, JOISTS, AND RAFTERS TO BE DF-#2

B. EXPOSED ARCH BEAMS TO BE DF-#1 OR BETTER

E. PLYWOOD SHEATHING SHALL BE AS FOLLOWS:

D. ALL STUDS TO BE DF#2 OR BETTER.

ENGINEER APPROVED EQUAL.

NAILING NOTES: (PER IRC TABLE R602.3(1))

JOIST TO SILL OR GIRDER

STUD TO SOLE PLATE

TOP PLATE TO STUD

DOUBLE TOP PLATES

CEILING JOISTS TO PLATE

BUILT-UP CORNER STUDS

PLYMOOD SUBFLOOR

CONTINUOUS HEADER TO STUD

PLYMOOD -OSB ROOF AND WALL

DOUBLE STUDS

RAFTER TO PLATE

SHEATHING

SOLE PLATE TO JOIST OR BLK'G

CONTINUOUS HEADER, TWO PIECES

TOP PLATES, LAPS AND INTERSECTIONS

CEILING JOISTS TO PARALLEL RAFTERS

UNLESS SPECIFIED IN ENGINEERS CALCULATIONS

C. SILLS, PLATES BLOCKING, AND BRIDGING TO BE DF-#2.

FIRE PROTECTION:

CONSTRUCTION:

CARPENTRY:

ALL SETBACKS, EASEMENTS AND CC&R REQUIREMENTS TO BE VERIFIED PRIOR TO CONSTRUCTION

FINAL SITING OF THE DWELLING SHALL BE THE SOLE RESPONSIBILITY OF THE CONTRACTOR

ALL HARDSCAPE DRAINAGE TO BE DIRECTED TO LANDSCAPE DRAINAGE CONTAINMENT OR CITY DRYWELL OR STORM WATER COLLECTION WHERE APPLICABLE

CONFIRM ALL UTILITIES AND TRENCH LOCATIONS WITH CONTRACTOR PRIOR TO CONSTRUCTION

PROVIDE EROSION CONTROL AND SILT FENCING AT PROJECT PERIMETER

GRADING NOTES:

SITE NOTES

CONTRACTOR TO VERIFY LOCATION OF ALL EXISTING UTILITIES. PROVIDE POSITIVE DRAINAGE AWAY FROM BUILDING. FINAL GRADE TO CONVEY SURFACE DRAINAGE TOWARD ROCK CHANNELS AND DISPERSION TRENCHES. DRAINAGE CONTAINMENT CALCULATIONS SHALL BE LISTED ON THE SITE DRAWINGS

AND BASED ON LOCAL CODE AREAS TO BE FILLED SHALL BE CLEARED, GRUBBED TO REMOVE TREES, VEGETATION, ROOTS AND OTHER OBJECTIONABLE MATERIAL AND STRIPPED OF TOPSOIL. PLACE FILL SLOPES WITH A GRADIENT STEEPER THAT 3:1 IN LIFTS NOT TO EXCEED 12

FOUNDATION NOTES

ANCHOR BOLTS TO BE SPACED AT 48" O.C. MAX U.N.O ON SHEAR WALL PLAN.

ENGINEERED RETAINING WALLS MAY BE REQUIRED @ ALL LOCATIONS WHERE THE DISTANCE FROM FOOTING TO THE TOP OF THE MATERIAL BEING RETAINED IS EQUAL TO OR GREATER THAN 4' OR IF THERE IS A SURCHARGE ON THE WALL. (I.E.- SLOPING HILL, DRIVEWAY OR GARAGE SLAB ABOVE)

CONTRACTOR TO VERIFY PLAN TO ACTUAL SITE CONDITIONS AND CONTACT ENGINEER IF RETAINING MALLS ARE REQUIRED.

STEP FOOTING AND STEMMALL AS REQUIRED BY GRADE.

PROVIDE CLOSEABLE FOUNDATION VENTS (1 PER 150 SQ')

INCHES, AND MAKE SURE EACH LIFT IS PROPERLY COMPACTED.

PROVIDE 6 MIL VAPOR BARRIER @ CRAWL SPACE.

TYP FOUNDATION WALL AT 1 STORY CONSTRUCTION TO BE 24"H X 6" CONC. WALL WITH (2) #4 BAR HORIZ. CONT. AND (1) #4 BAR YERT @ 48" O/C.

TYP FOUNDATION WALL AT 2 STORY CONSTRUCTION TO BE 24"H X 8" CONC. WALL WITH (2) #4 BAR HORIZ. CONT. AND (1) #4 BAR YERT @ 48" O/C.

FOR 36"H WALL PROVIDE (3) #4 BAR HORIZ. CONT. AND (1) #4 BAR VERT. @ 24" O/C. FOR 48"H WALL PROVIDE (4) #4 BAR HORIZ. CONT. AND (1) #4 BAR VERT. @ 24" O/C.

TYP STRIP FOOTING AT 1 STORY FOUNDATION WALL TO BE 12"W X 6"D CONC FOOTING WITH (2) #4 BAR CONT.

TYP STRIP FOOTING AT 2 STORY FOUNDATION WALL TO BE 16"W X 8"D CONC FOOTING WITH (2) #4 BAR CONT.

FLOOR FRAMING NOTES

AT LOWER FLOOR USE 3/4" T&G PLYWOOD OR 3/4" EDGEGOLD SUBFLOOR OVER 9 1/2" I JOISTS.

AT UPPER FLOOR USE 3/4" T&G PLYMOOD OR 3/4" EDGEGOLD SUBFLOOR OVER 11 7/8" I JOISTS.

GLUE AND NAIL W/ 8D NAILS @ 6" O.C. EDGES & 12" FIELD U.N.O.

SEE MANUFACTURERS PLAN FOR SPACING & TYPE.

WHERE TOP OF FLOOR BEAMS ARE EVEN WITH TOP OF JOISTS PROVIDE APPROPRIATE SIMPSON TOP FLANGE OR FACE MOUNT HANGER.

NAIL RIM BOARD TO SILL PLATE @ 4" O.C. U.N.O. IN ENGINEERS CALCULATIONS

WALL FRAMING NOTES

STRUCTURAL CONNECTORS TO BE SIMPSON (OR EQ.) INSTALLED WITH MAX. NAILING. USE GALVANIZED NAILS WHERE EXPOSED TO WEATHER.

ALL EXTERIOR WALLS TO BE 2X6 #2 DF STUDS @ 16" O.C. W/ 7/16" O.S.B. OR SIM. INSTALLED W/ 8D NAILS @ 6" O.C. EDGES & 12" FIELD U.N.O.

ALL INTERIOR WALLS TO BE 2X4 #2 DF STUDS @ 16" O.C.

TYP. HEADER 4X8 #2 DF U.N.O.

TYP. HEADER BEARING SUPPORT- (1) 2X TRIMMER & (1) 2X KING STUD U.N.O. PLACE DBL TRIMMERS @ HEADERS OVER 10" IN DEPTH OR OPENINGS GREATER THAN 8' IN WIDTH.

PROVIDE FULL WIDTH 2X BEARING UNDER ALL BEAM SUPPORT POINTS TO FOUNDATION

REFERENCE PLANS FOR BEAM SIZES OR STRUCTURAL CONNECTIONS NOT DEFINED

REFERENCE PLANS FOR ADDITIONAL ENGINEERS SPECIFICATIONS

ALL FRAMING AND FASTENING SHALL COMPLY TO THE MOST CURRENT LOCAL BUILDING

GENERAL PLUMBING & HVAC NOTES: 1. HVAC SHALL BE ZONED WHERE APPLIES

2. THE HEAT SOURCE SHALL CONFORM TO THE SPECIFICATIONS SET FORTH IN THE ADDITIONAL ENERGY MEASURES SUPPLIED FOR THIS PROJECT

3. METALLIC GAS PIPE, WATER PIPE, AND FOUNDATION REINFORCING BARS SHALL BE BONDED TO THE ELECTRICAL SERVICE GROUND.

- 4. DRYER, WATER HEATER, KITCHEN AND BATHROOM VENTING SHALL EXHAUST TO THE OUTSIDE OF THE BUILDING AND BE EQUIPPED WITH A BACK DRAFT DAMPER.
- 5. ALL GAS LINES SHALL BE SIZED FOR APPLIANCE LOAD. "BLACK" PIPE SHALL BE USED INSIDE THE BUILDING, "GREEN" PIPE WHERE UNDERGROUND OR EXPOSED TO WEATHER. ALL JOINTS
- SHALL BE TAPED WHERE BURIED OR EXPOSED TO WEATHER. 6. TUBS/SHOWERS SHALL BE PROVIDED WITH INDIVIDUAL CONTROL VALVES OF THE PRESSURE BALANCE OR THE THERMOSTATIC MIXING TYPE. THE WATER TEMPERATURE SHALL BE AT A
- MAXIMUM OF 120*F. 7. A MINIMUM OF ONE EXTERIOR HOSE BIB SHALL BE SUPPLIED- CONFIRM WITH BUILDER
- 8. HEAT DUCTING SHALL BE SECURED, SEALED AND INSULATED AS REQUIRED BY THE ENERGY MEASURES.
- 9. INSTALL WATERPROOF GYPSUM BOARD AT ALL WATER SPLASH AREAS TO MINIMUM 70" ABOVE SHOWER DRAINS.

10. INSULATE WASTE LINES FOR SOUND CONTROL.

DOOR AND WINDOW NOTES

BASEMENTS AND EVERY BEDROOM SHALL BE PROVIDED WITH AN EGRESS WINDOW. FINISH SILL HEIGHT SHALL NOT BE GREATER THAN 44" ABOVE THE FINISH FLOOR HEIGHT AND SHALL HAVE A MINIMUM OPENABLE AREA OF 5.7 SQ. FT. AT UPPER FLOOR LEVELS.

RESERVED FOR BUILDING DEPARTMENT STAMP

EGRESS WINDOWS AT GRADE FLOOR SHALL HAVE A MINIMUM OPENABLE AREA OF 5.0 SQ.FT. EGRESS MINDOMS SHALL NOT HAVE AN OPENABLE AREA LESS THAN 20" MIDE OR 24" HIGH.

OPERABLE WINDOWS INSTALLED WHERE THE SILL IS LESS THAN 24" ABOVE FINISH FLOOR INTERIOR AND GREATER THAN 72" ABOVE GRADE OR OTHER SURFACE SHALL HAVE AN APPROVED WINDOW OPENING CONTROL DEVICE (WOCD) OR SIMILAR.

WINDOWS IN HAZARDOUS LOCATIONS PER R308.4 SHALL HAVE SAFETY GLAZING PER R308.1

INTERIOR DOORS SHALL BE PAINTED OR STAINED. ENTRY DOOR TO BE DEFINED BY HOME OWNER PRIOR

DOORS BETWEEN GARAGE AND LIVING AREA SHALL BE 1-3/4" TIGHT FITTING SOLID CORE DOORS WITH A RATING OF 20 MINUTES.

AT LEAST ONE EXTERIOR EXIT DOOR WILL BE 36" MIN. NET CLEAR DOORWAY SHALL BE 32" MIN. DOOR SHALL BE OPENABLE FROM INSIDE WITHOUT THE USE OF A KEY OR ANY SPECIAL KNOWLEDGE OR EFFORT. GLAZING IN DOORS SHALL BE DUAL PANE SAFETY GLASS WITH MIN. U-VALUE OF 0.60

GARAGE DOORS TO BE SECTIONAL, OVERHEAD DOORS

RAILING NOTES:

STAIRWAYS SHALL HAVE A MIN, WIDTH OF 34". HAND RAILS MAY ENCROACH A MAX, OF 3 1/2" INTO THE REQUIRED

TREADS SHALL HAVE A MIN. WIDTH OF 9". STAIR TREADS MUST BE UNIFORM AND CAN NOT VARY FROM THE LARGEST TO THE SMALLEST BY MORE THAN 3/8".

STAIRWAYS SHALL HAVE MIN. 6'-8" OF HEADROOM AT THE NOSE OF THE STAIR.

ENCLOSED USABLE SPACE UNDER INTERIOR STAIRS SHALL BE PROTECTED ON THE ENCLOSED FACE WITH 5/8" TYPE "X" GYPSUM WALL BOARD.

STAIRWAYS SHALL HAVE AT LEAST ONE HANDRAIL LOCATED 34" TO 38" ABOVE THE NOSING OF TREADS AND LANDINGS. THE HAND GRIP PORTION OF HANDRAILS SHALL NOT BE LESS THAN 1-1/2" OR GREATER THAN 2" IN CROSS-SECTIONAL DIMENSION.

HANDRAILS SHALL BE CONTINUOUS THE FULL LENGTH OF THE STAIRS. THE ENDS OF HANDRAILS SHALL RETURN TO WALL OR TERMINATE INTO A NEWEL POST OR SAFETY TERMINAL

STAIRWAYS HAVING LESS THAN 2 RISERS DO NOT REQUIRE A HAND RAIL

34" MIN. HEIGHT GUARDRAILS SHALL BE PROVIDED FOR AT PORCHES, DECKS, BALCONIES, STAIRWAYS AND LANDINGS WHERE THE ADJACENT SURFACE IS GREATER THAN 24" BELOW.

RAILING AND GUARDRAIL BALUSTER SPACING SHALL BE NO GREATER THAN 4".

THE TRIANGULAR OPENINGS FORMED BY THE RISER, TREAD, AND BOTTOM OF GUARDRAIL SHALL NOT ALLOW A 6" DIAMETER SPHERE TO PASS THROUGH

EXTERIOR SPIRAL STAIRS TO BE FABRICATED AND INSTALLED PER THE MFG. INSTRUCTIONS.

ELECTRICAL, DATA, & AUDIO NOTES: HOME OWNER SHALL DO A WALK-THRU WITH RELEVANT INSTALLERS TO VERIFY THE EXACT LOCATION FOR

OUTLETS, LIGHTS, SWITCHES, CABLE, DATA, PHONE, AUDIO, ETC.

ELECTRICAL NOTES:

1. ELECTRICAL RECEPTACLES IN BATHROOMS, KITCHENS AND GARAGES SHALL BE G.F.I. ORG.F.I.C. PER NATIONAL ELECTRICAL CODE REQUIREMENTS.

2. PROVIDE ONE SMOKE DETECTOR IN EACH ROOM AND ONE SMOKE / CARBON MONOXIDE DETECTOR IN EACH CORRIDOR ACCESSING BEDROOMS WITHIN 15 FEET. CONNECT SMOKE DETECTORS TO HOUSE POWER AND INTER-CONNECT SMOKE DETECTORS SO THAT, WHEN ANY ONE IS TRIPPED, THEY ALL WILL SOUND. PROVIDE

(SEE R314 & R315)

BATTERY BACKUP FOR ALL UNITS.

1. CIRCUITS SHALL BE VERIFIED WITH HOME OWNER PRIOR TO WIRE INSTALLATION. 2. FINAL SMITCHES FOR TIMERS AND DIMMERS SHALL BE VERIFIED MITH HOME OWNER.

3. FIXTURES TO BE SELECTED BY HOME OWNER.

1. LOCATE SPEAKERS AND AUDIO CONTROLS AS INDICATED IN THE PLAN; RUN CIRCUIT OF SPEAKER WIRING TO

AUDIO HOME PANEL SPECIFIED BY FLOOR; 2. AUDIO SPEAKERS TO BE APPROVED BY HOME OWNER;

3. LOCATE JACKS AS INDICATED IN THE PLAN; INSTALL DATA / CABLE PANEL SIMILAR TO "ON Q". SYSTEM TO BE APPROVED BY HOME OWNER.

DATA / CABLE:

LOCATE SECURITY PANELS AS INDICATED IN THE PLAN: SYSTEM TO BE APPROVED BY HOME OWNER.

DATE:

4/16/2015

SCALE: 1/4"=1' U.N.O.

SHEET TITLE:

PLAN NOTES

SHEET:

A0.02

REVISION TABLE

TE REV BY DESCRIPTION

1/2015 ROB LITTLETON ARC PRELIM

7T 119 NBREY PARK, PHASE 3

ENNA BUILDING 11-241-0406

AND DESIGN
0-1120 PH PO BOX 7167
-1744 FAX BEND OR,97708
CCB# 165287

OB INCETON INC.

DATE:


4/16/2015

SCALE:

1/4"=1' U.N.*O*.

SHEET TITLE:
SITE PLAN

SHEET: A1.01

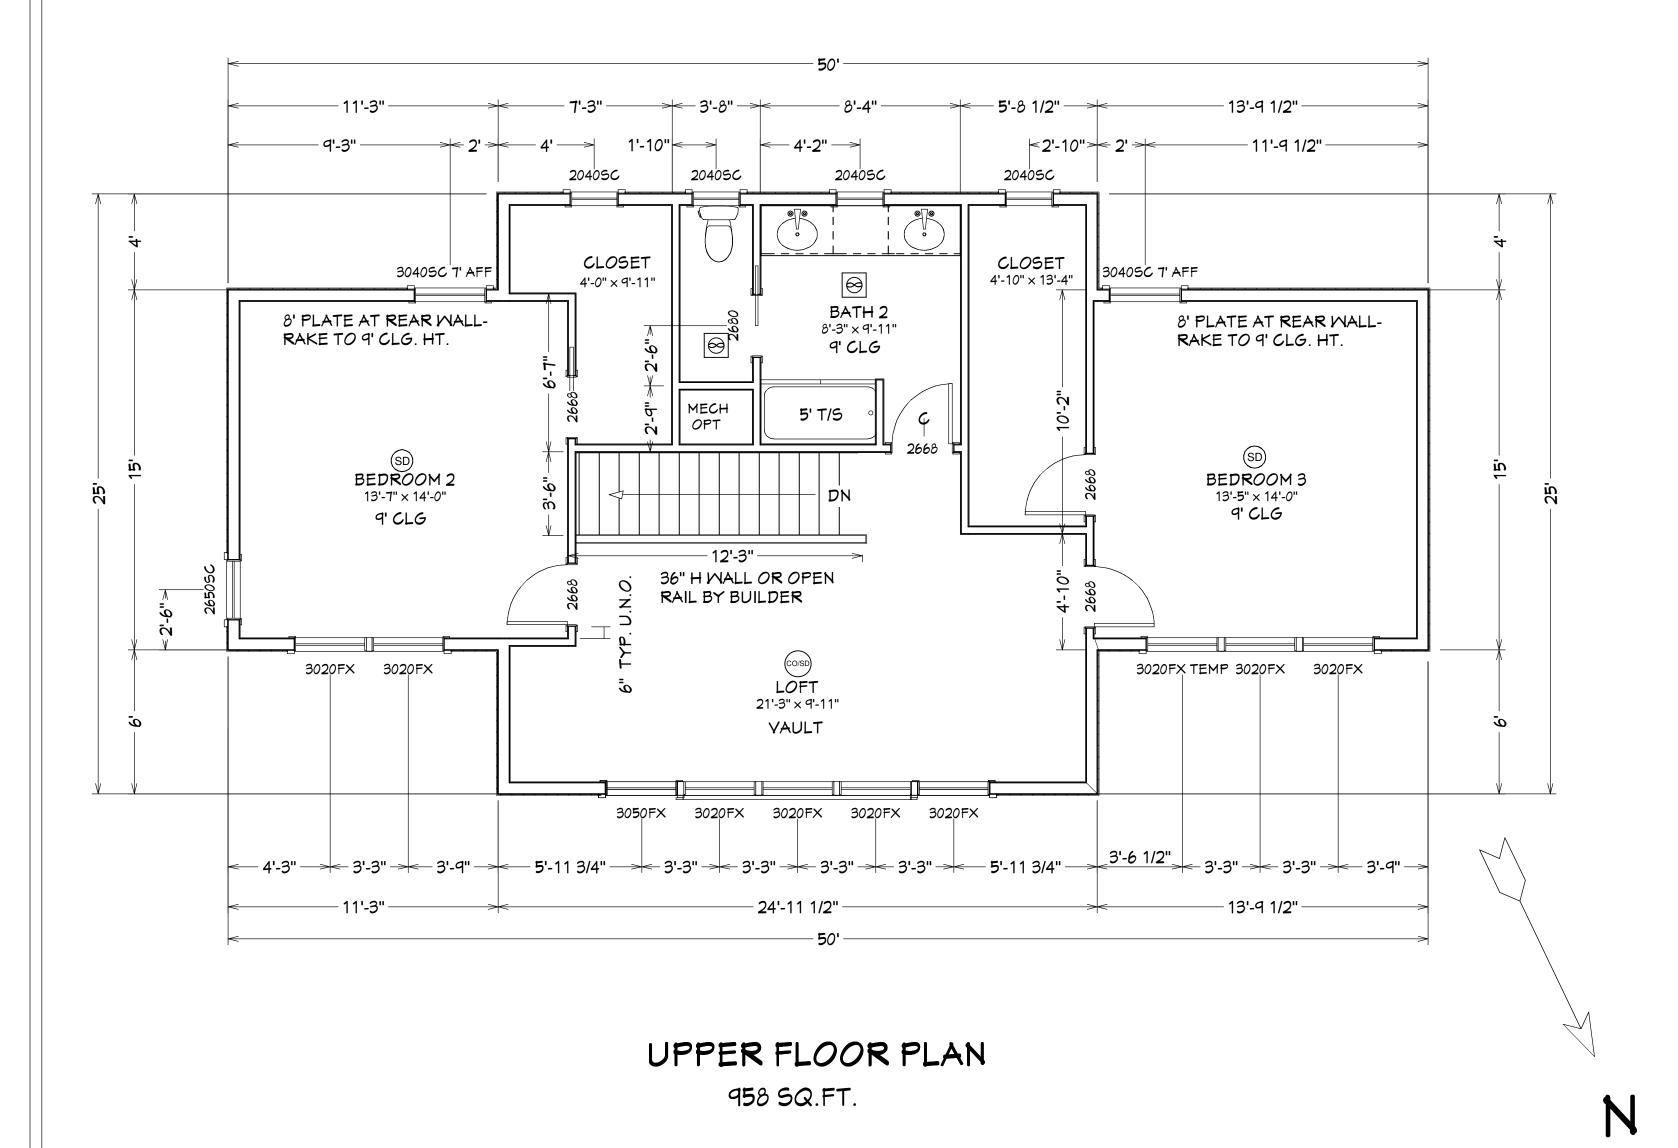

BUILDING SECTION

TO BE PROVIDED

DATE:

4/16/2015

SCALE: 1/4"=1' U.N.O.

SHEET TITLE: FLOOR PLAN BLDG SECTION

SHEET:

A1.03

