


RENEWS 12-31-2018

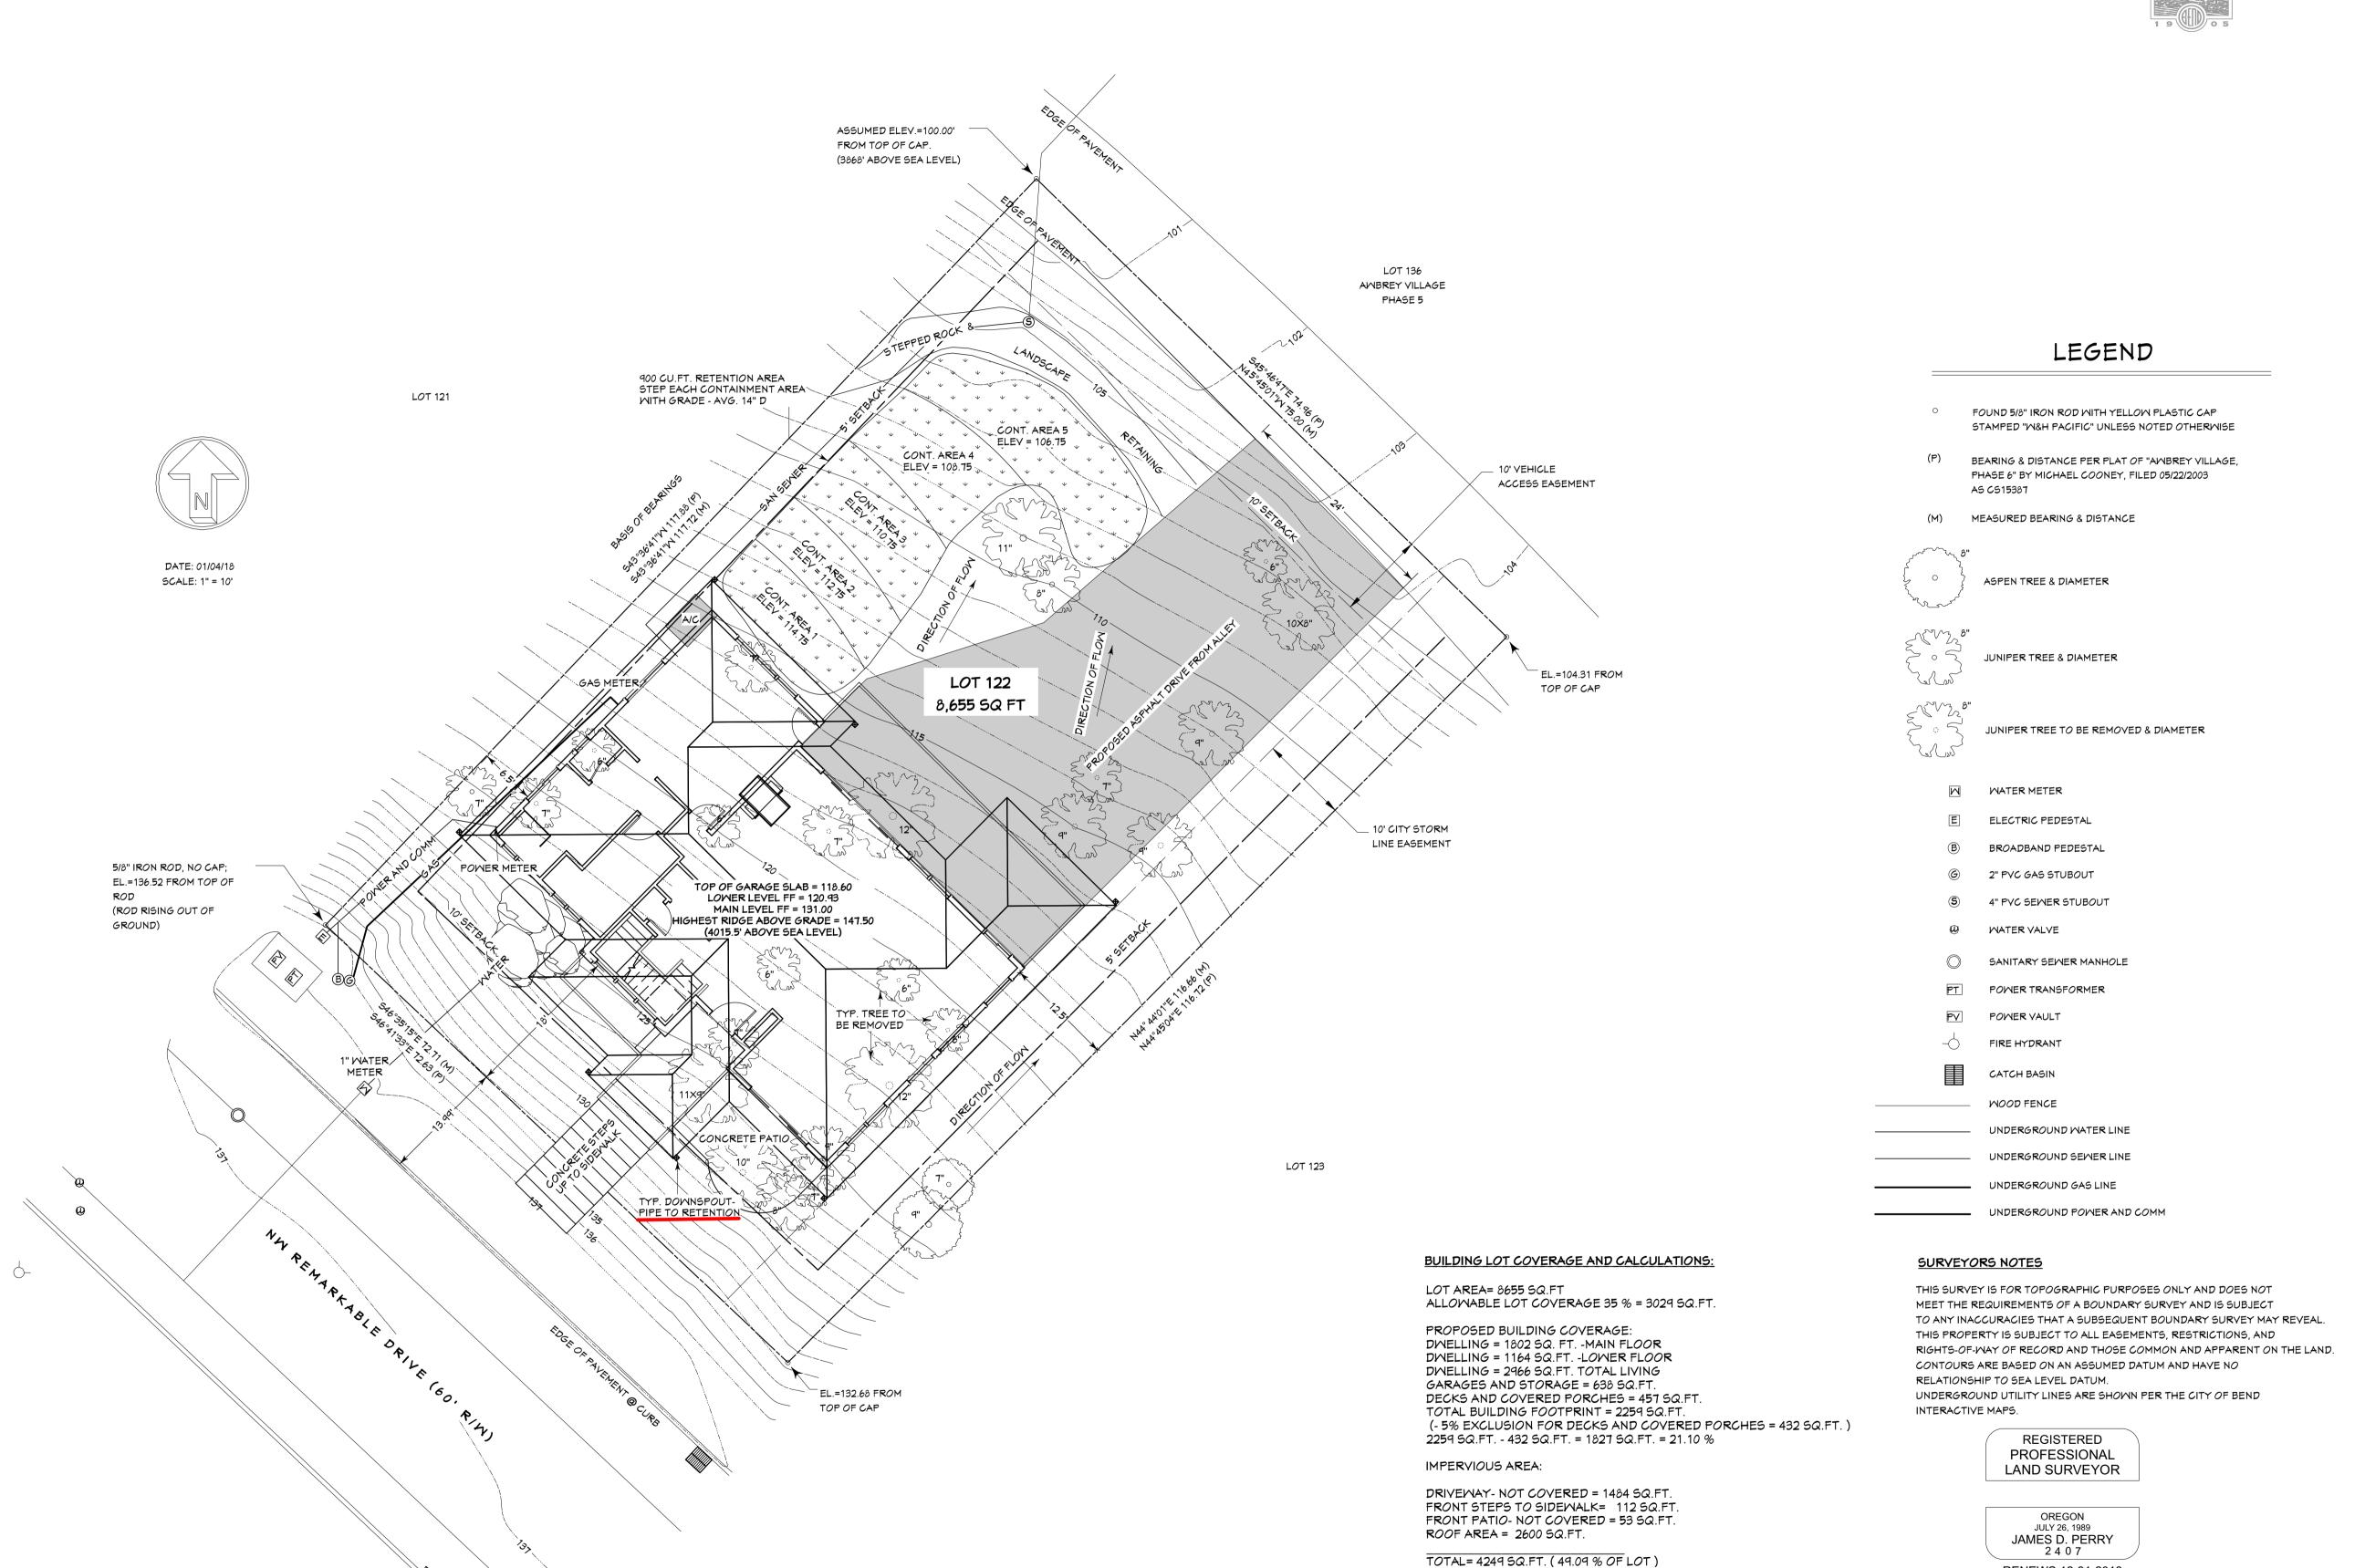

DATE:

5/8/2018

SCALE: 1/4"=1' U.N.O.

SHEET TITLE: SITE PLAN

> SHEET: A1.01

TOTAL RETENTION REQUIRED = 850 CUBIC FEET



		SH	HEARWALL SCHE	EDULE			
MALL INFORMATION				FAST			
MALL	WALL SHEATHING	EDGE NAILING	FIELD NAILING	SILL PLATE	RIM JOIST	FOUNDATION ANCHORS	ALLOWABLE LOAD
SM-6	7/16" on one side of wall	8d <b>@</b> 6" o.c.	8d <b>@</b> 12" o.c.	16d <b>@</b> 6" o.c.	Simpson LS50 @ 24" o.c.	1/2"Ø×10" A.B. <b>@</b> 48" o.c.	255
SM-4	7/16" on one side of wall	8d <b>@</b> 4" o.c.	8d <b>@</b> 12" o.c.	16d <b>@</b> 4" o.c.	Simpson LS <b>5</b> 0 <b>@</b> 18" o.c.	1/2"Ø×10" A.B. <b>@</b> 30" o.c.	395
5M-3 Notes: a,b,c	7/16" on one side of wall	8d <b>@</b> 3" o.c.	8d <b>@</b> 12" o.c.	16d <b>@</b> 3" o.c.	Simpson LS50 @ 16" o.c.	1/2"Φ×10" A.B. @ 24" ο.c.	770


## SCHEDULE NOTES:

- All exterior framed walls not designated with a wall label shall be sheathed and anchored according
- to the requirements of shear wall 6.
   Studs shall be spaced at 24" o.c. maximum (plywood may be installed either vertically or
- horizontally)

   All shear panels are to be continuous between horizontal diaphragms (roof to floor, floor to floor,
- floor to foundation)
- All framed shear walls shall be blocked at all panel edges.

## Footnotes: Were load is >350 plf use a) b) and c)

- a) Studs and/or blocking at adjoining panel edges shall be 3x minimum and the nails shall be
- b) Sill plates shall be 3x minimum and sill plate nailing shall be staggered.
- c) As a substitute for 3x members, double studs may be nailed together with 16d nails @ 6" o.c.

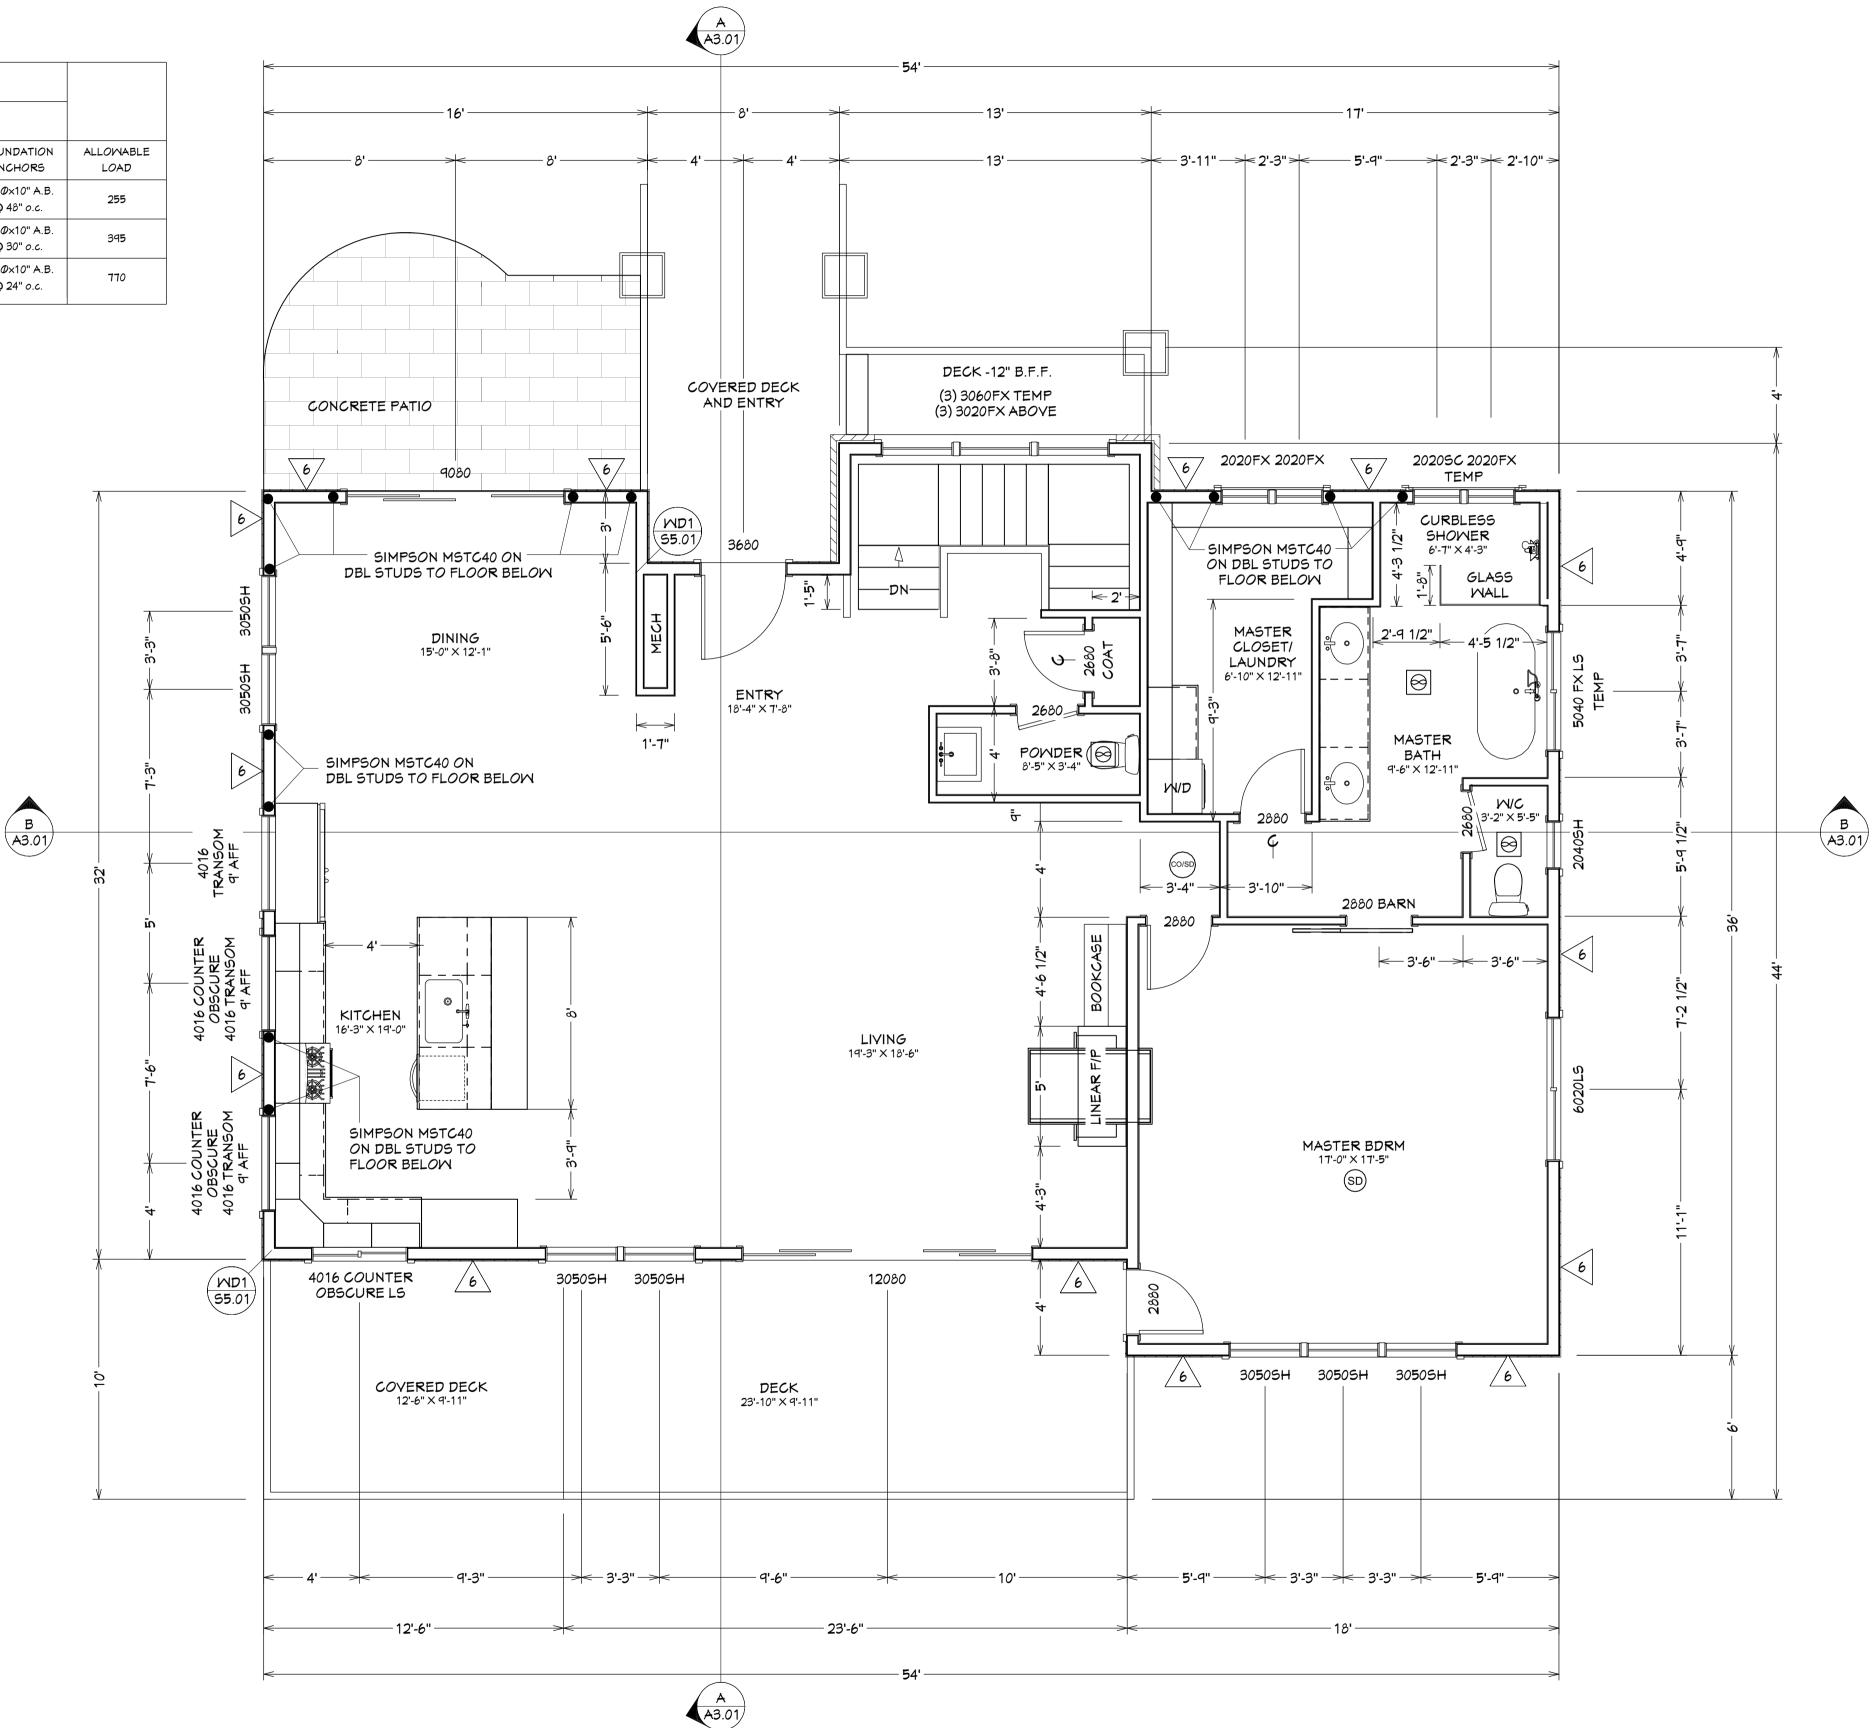

Interconnected hard wired smoke detectors required located in each bedroom, immediately outside bedroom and one on each story. (R314.3). Carbon Monoxide alarms shall be located in each room or within 15 feet outside of each bedroom door. Bedrooms on separate floor levels in a structure consisting of two or more stories shall have separate carbon monoxide alarms serving each story. (R315.2)

Exhaust Rates for Residential Dwellings
Table M1507.4
Range hoods/ downdraft exhaust Min. 150 cfm
intermittent. Exhaust to outside.
Rooms containing bathing and spa facilities
Min. 80 cfm intermittent or 20 cfm continuous
Toilet rooms without bathing or spa facilities,
when not provided with natural ventilation in
accordance with Section R303.3.2 Min. 50 cfm

Handrails/Stairways
Stairways shall comply with R311.7 Handrails
shall be provided on at least one side of each
continuous run of treads or flight with four or
more risers. Handrail height, measured
vertically from the sloped plane adjoining the
tread nosing, or finished surface of the ramp
slope, shall be not less than 30 inches and not
more than 38 inches. R311.7.7, R311.7.7.1

Fireblock Protection R302.11 Fire blocking. In combustible construction, fire blocking shall be provided to cut off all concealed draft openings (both vertical and horizontal) and to form an effective fire barrier between stories, and between a top story and the roof space.

R310 Emergency Egress
Where emergency escape and rescue openings are provided they shall have a sill height of not more than 44 inches (1118 mm) above the floor. R310.1.1 Minimum opening area. All emergency escape and rescue openings shall have a minimum net clear opening of 5.7 square feet (0.530 m2). Exception: Grade floor openings shall have a minimum net clear opening of 5 square feet (0.465 m2). R310.1.2 Minimum opening height. The minimum net clear opening height shall be 24 inches (610 mm). R310.1.3 Minimum opening width. The minimum net clear opening width shall be 20 inches (508 mm). R310.1.4 Operational constraints. Emergency escape and rescue openings shall be operational from the inside of the room without the use of keys, tools or special knowledge. Minimum sill height 24" or per R612.2.

Tempered- Door 24"
Safety glazing required when located adjacent to a door with nearest vertical edge located within 24 inches in closed position and bottom of glazing less than 60 inches above walking service. Exception given when wall with glazing is perpendicular to door and door does not swing towards glazing. (R308.4 #2)

Tempered- Shower/Bathtub Glazing in enclosures for or walls facing hot tubs, whirlpools, saunas, steam rooms, bathtubs and showers where the bottom exposed edge of the glazing is less than 60 inches measured vertically above any standing or walking surface. (R308.4 #5)

Tempered- Stairway
Safety glazing required adjacent to stairways
when within 36 inches horizontally of walking
service and glazing less than 60 inches above
walking surface, also required within 60 inches
horizontally of bottom tread when glazing less
than 60 inches above walking surface. One
tread constitutes stairway per building
code.(R308.4 #7)

PLUMBING OR ELECTRICAL HAS NOT BEEN REVIEWED

MAIN FLOOR PLAN 1802 SQ.FT. NUMBER DATE REV BY DESCRIPTION

1226 NW REMARKABLE BEND OR 97703

> IENNA BUILDING COMPA TEVE MCDOWELL 11-241-0406

> > AND DESIGN 30-1120 PH PO BOX 7167 3-1744 FAX BEND OR,9770 CCB# 165287

> > > COB LETON INC

3/23/2018

DATE:

5CALE: 1/4"=1' U.N.O.

SHEET TITLE: MAIN FLOOR PLAN

SHEET: A1.02


			IEARWALL SCHE				
WALL INFORMATION				FASTENERS (Where Applicable)			
MALL	MALL SHEATHING	EDGE NAILING	FIELD NAILING	SILL PLATE	RIM JOIST	FOUNDATION ANCHORS	ALLOMABLE LOAD
SM-6	7/16" on one side of wall	8d <b>@</b> 6" o.c.	8d <b>@</b> 12" o.c.	16d <b>@</b> 6" o.c.	Simpson LS50 @ 24" o.c.	1/2"Ø×10" A.B. <b>@</b> 48" o.c.	255
SM-4	7/16" on one side of wall	8d @ 4" o.c.	8d @ 12" o.c.	16d <b>@</b> 4" o.c.	Simpson LS50 @ 18" o.c.	1/2"Ø×10" A.B. @ 30" o.c.	395
SM-3 Notes: a,b,c	7/16" on one side of wall	8d <b>@</b> 3" o.c.	8d <b>@</b> 12" o.c.	16d @ 3" o.c.	Simpson L550 <b>@</b> 16" o.c.	1/2"Ø×10" A.B. @ 24" o.c.	770

A3.01

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- floor to foundation) • All framed shear walls shall be blocked at all panel edges.

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LOWER FLOOR PLAN 1164 SQ.FT. GARAGE AND STORAGE AREA 638 SQ.FT.

	TABLE	DESCRIPTION				
	REVISION TABLE	REV BY				
		DATE				
		NUMBER DATE				

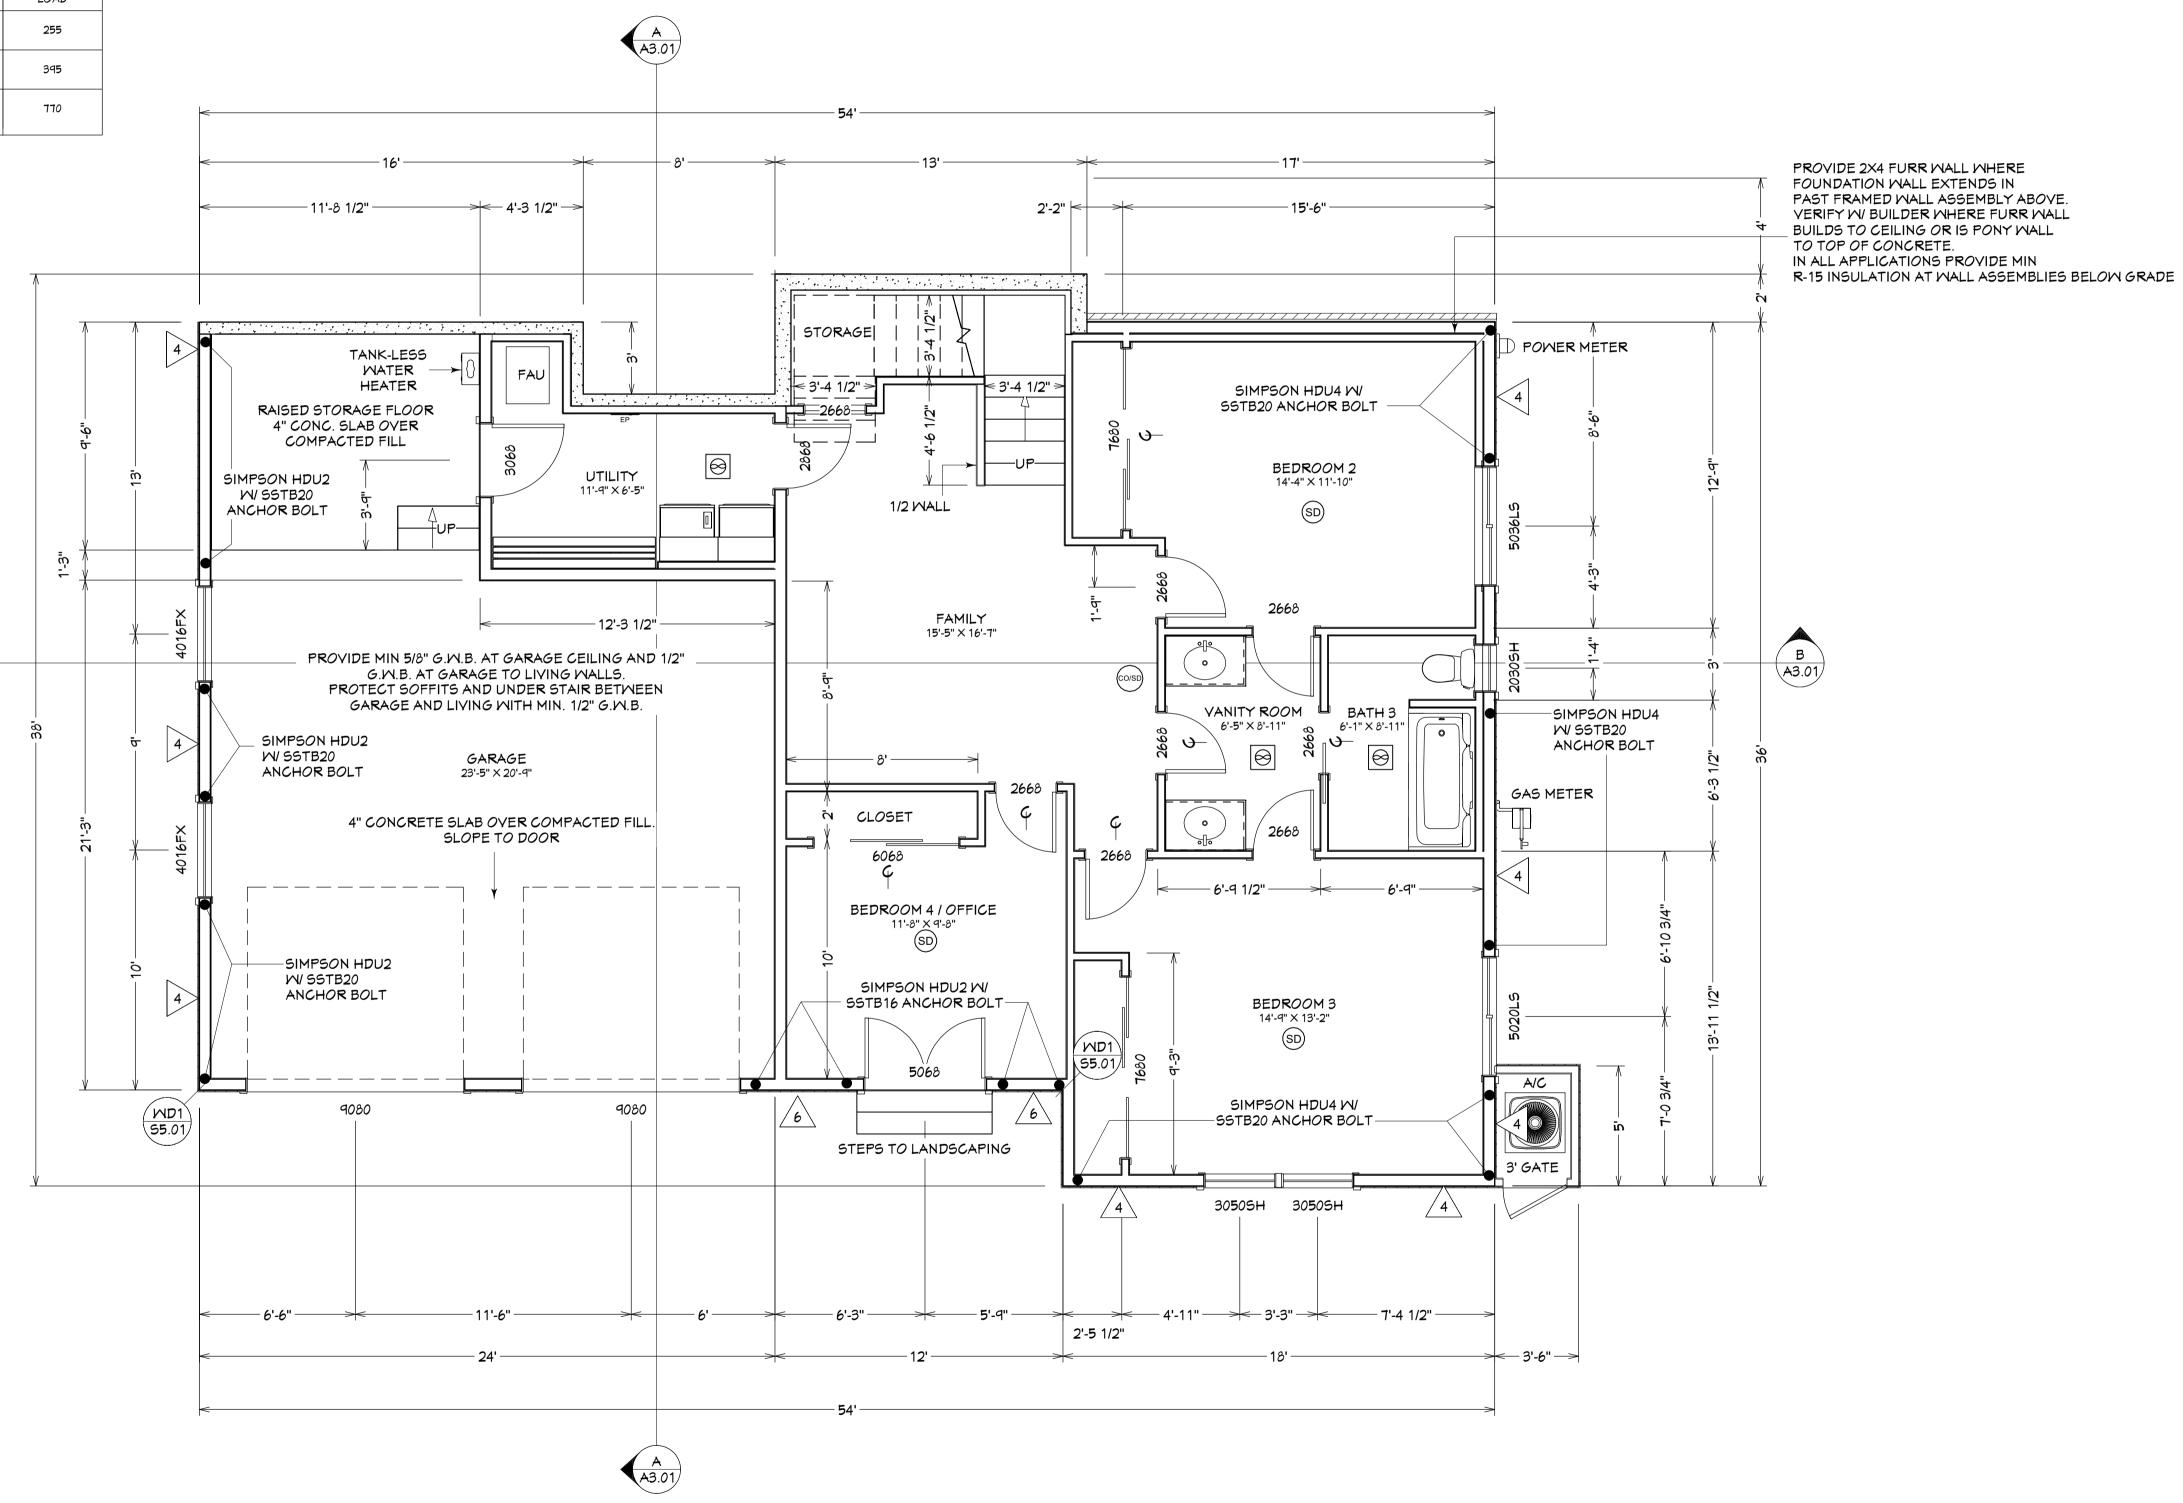DATE:


5/8/2018


SCALE:

1/4"=1' U.N.O. SHEET TITLE:

LOWER FLOOR PLAN

SHEET: A1.03

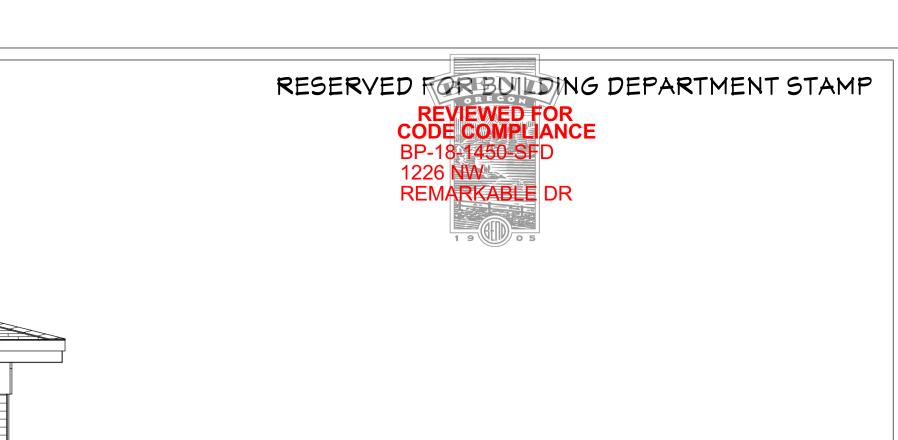

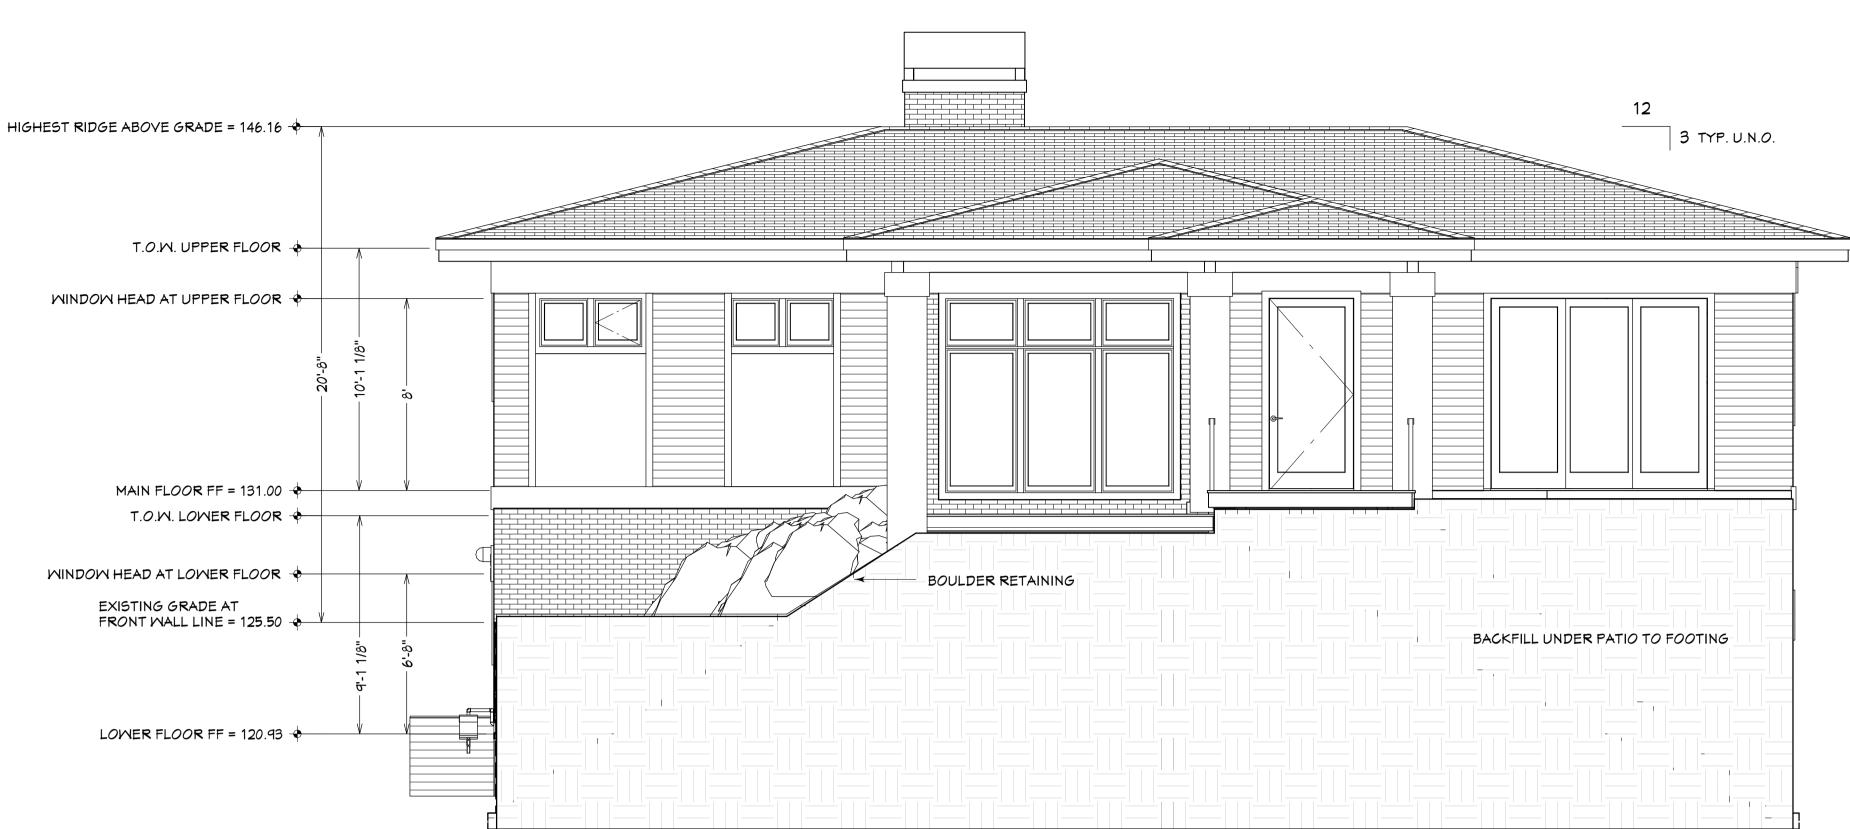

# FRONT ELEVATION



REAR ELEVATION

DATE: 3/22/2018 SCALE: 1/4"=1' U.N.O. SHEET TITLE:

EXTERIOR ELEVATIONS

SHEET: A2.01

